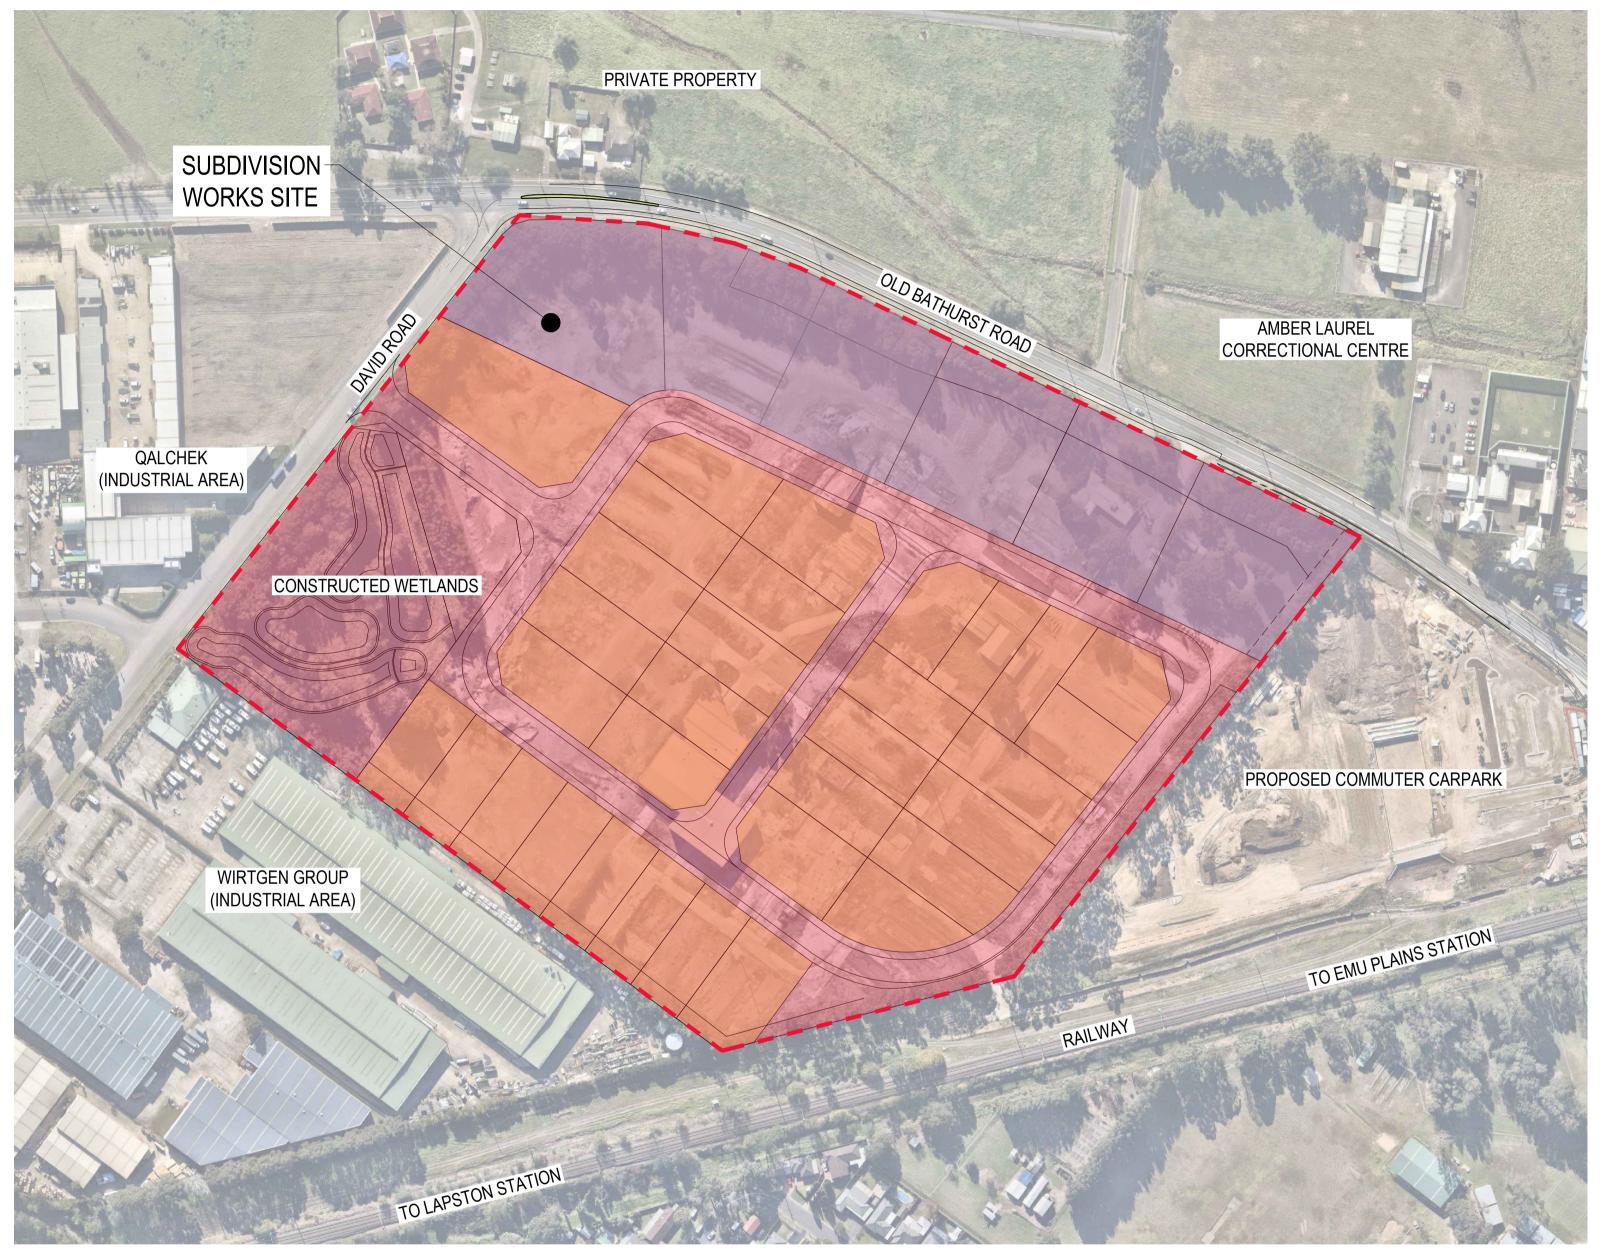
INDUSTRIAL DEVELOPMENT 158-164 OLD BATHURST ROAD, EMU PLAINS, NSW 2750


CIVIL ENGINEERING SERVICES - DEVELOPMENT APPLICATION

DWG No.	DESCRIPTION	REV	C7.102	STORMWATER MANAGEMENT - CATCHMENT PLAN - PRE-DEVELOPMENT	С
C1.001	COVER SHEET AND DRAWING INDEX	С	C7.111	STORMWATER MANAGEMENT - CATCHMENT PLAN	С
C1.101	NOTES AND LEGENDS	С	C7.201	STORMWATER MANAGEMENT - TYPICAL DETAILS - SHEET 1	С
C1.401	SUBDIVISION - PLAN	С	C7.202	STORMWATER MANAGEMENT - TYPICAL DETAILS - SHEET 2	С
C1.501	TREE MANAGEMENT - PLAN	С	C7.203	STORMWATER MANAGEMENT - TYPICAL DETAILS - SHEET 3	С
C2.001	BULK EARTHWORKS - PLAN	С	C7.204	STORMWATER MANAGEMENT - TYPICAL DETAILS - SHEET 4	С
C2.101	BULK EARTHWORKS SECTIONS - SECTION 01 - 02	С	C7.401	STORMWATER MANAGEMENT - LONGITUDINAL SECTION - SHEET 1	С
C2.102	BULK EARTHWORKS SECTIONS - SECTION 03 - 04	С	C7.402	STORMWATER MANAGEMENT - LONGITUDINAL SECTION - SHEET 2	С
C2.103	BULK EARTHWORKS SECTIONS - SECTION 05 - 06	С	C7.403	STORMWATER MANAGEMENT - LONGITUDINAL SECTION - SHEET 3	С
C2.104	BULK EARTHWORKS SECTIONS - SECTION 07	С	C7.404	STORMWATER MANAGEMENT - LONGITUDINAL SECTION - SHEET 4	С
C3.001	GENERAL ARRANGEMENT - SITEWORKS AND GRADING	С	C7.405	STORMWATER MANAGEMENT - LONGITUDINAL SECTION - SHEET 5	С
C3.101	GENERAL ARRANGEMENT - SIGNAGE AND LINEMARKING	С	C7.406	STORMWATER MANAGEMENT - LONGITUDINAL SECTION - SHEET 6	С
C3.301	GENERAL ARRANGEMENT - COMBINED SERVICES PLANS	С	C7.407	STORMWATER MANAGEMENT - LONGITUDINAL SECTION - SHEET 7	С
C5.101	ROAD DESIGN - TYPICAL ROAD CROSS SECTION - STANDARD DETAILS	С	C7.408	STORMWATER MANAGEMENT - LONGITUDINAL SECTION - SHEET 8	С
C5.102	ROAD DESIGN - TCS DESIGN	С	C7.409	STORMWATER MANAGEMENT - LONGITUDINAL SECTION - SHEET 9	С
C5.201	ROAD DESIGN - LONGITUDINAL SECTION - MC01	С	C7.410	STORMWATER MANAGEMENT - LONGITUDINAL SECTION - SHEET 10	С
C5.202	ROAD DESIGN - LONGITUDINAL SECTION - MC01	С	C7.411	STORMWATER MANAGEMENT - LONGITUDINAL SECTION - SHEET 11	С
C5.203	ROAD DESIGN - LONGITUDINAL SECTION - MC02	С	C7.412	STORMWATER MANAGEMENT - LONGITUDINAL SECTION - SHEET 12	С
C5.204	ROAD DESIGN - LONGITUDINAL SECTION - MC03	С	C8.001	SOIL EROSION AND SEDIMENT CONTROL - PLAN	С
C7.001	STORMWATER MANAGEMENT - PLAN	С	C8.101	SOIL EROSION AND SEDIMENT CONTROL - NOTES AND DETAILS	С
C7.002	STORMWATER MANAGEMENT - PLAN - WETLAND	С	C11.001	WASTE MANAGEMENT - PLAN	С
C7.003	STORMWATER MANAGEMENT - SECTIONS - WETLAND	С	C15.001	TURNING PATHS - SHEET 1	С
C7.101	STORMWATER MANAGEMENT - STRATEGY PLAN	С	C15.002	TURNING PATHS - SHEET 2	С



LOCALITY PLAN

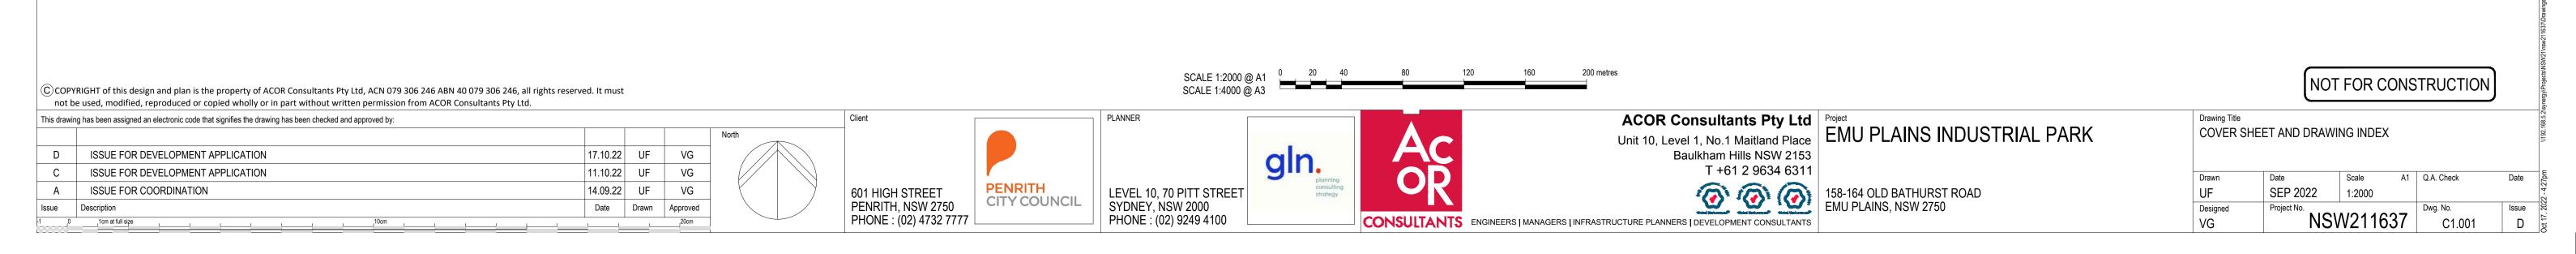NOT TO SCALE



GENERAL NOTES

- ALL WORK TO BE IN ACCORDANCE WITH PENRITH CITY COUNCIL STANDARD DRAWINGS AND SPECIFICATIONS, AND TO THE REQUIREMENTS OF COUNCIL ENGINEERS.
- A SURVEY OF THE SITE HAS BEEN UNDERTAKEN BY VINCE MORGAN SURVEYORS AS RECEIVED BY ACOR CONSULTANTS PTY LTD' ON 24.03.22 ALL LEVELS TO A.H.D. DRAWINGS SHOW DETAILS AT THE TIME OF SURVEY. REFERENCE NUMBER: 23978T(D)
- ALL RUBBISH, DEBRIS, UNDERGROWTH, FENCES & TREES NOTED ON THE PLAN WITHIN THE LIMIT OF WORKS ARE TO BE REMOVED FROM SITE AREA TO THE SATISFACTION OF COUNCIL OR THE SUPERINTENDENT
- NO DISTURBANCE TO THE SITE SHALL BE PERMITTED OTHER THAN IN THE IMMEDIATE AREA OF THE WORKS AND NO MATERIAL SHALL BE REMOVED FROM SITE WITHOUT COUNCIL
- NO WORK WITHIN ADJOINING PROPERTIES TO BE UNDERTAKEN WITHOUT WRITTEN PERMISSION FROM THE OWNERS OR RESPONSIBLE AUTHORITY
- 6. THE CONTRACTOR SHALL OBTAIN LEVELS FROM ESTABLISHED BENCHMARKS ONLY
- THE LOCATION OF RECOVERY MARKS AND BENCH MARKS SHOULD BE VERIFIED AND CONFIRMED BY THE CONTRACTOR AND ANY DISCREPANCIES SHOULD BE CLARIFIED IN WRITING WITH THE SURVEYOR PRIOR TO THE COMMENCEMENT OF WORK
- THE CONTRACTOR SHALL ERECT A POLLUTION WARNING SIGN AT THE ENTRANCE TO THE SUBDIVISION OR PROPOSED DEVELOPMENT
- SERVICE CONDUITS SHALL BE PLACED AS DIRECTED BY INTEGRAL ENERGY. NBN / TELSTRA. AND AS REQUIRED BY THE RELEVANT SERVICE AUTHORITY AND AS PER SERVICE AUTHORITY
- 10. STREET SIGNS REQUIRED WHERE SHOWN. STREET SIGNS TO COUNCIL STANDARD SHALL BE INSTALLED BY THE CONTRACTOR.
- 11. SIGNPOSTING AND LINEMARKING TO CONFORM WITH AS1742 2 & AS1743. RAISED RETRO-REFLECTIVE PAVEMENT MARKERS TO CONFORM WITH AS1906 & AS1743.
- 12. KERB RAMP CROSSINGS TO BE PROVIDED WHERE SHOWN ON PLAN AND CONSTRUCTED AS DETAILED AND TO COUNCIL STANDARDS
- 13. NO TREES ARE TO BE REMOVED OR LOPPED OTHER THAN THOSE SHOWN AND THOSE IN ROAD RESERVES, WITHOUT COUNCILS WRITTEN PERMISSION. A TREE INSPECTION WITH COUNCIL SHALL BE ARRANGED ONCE LOTS HAVE BEEN PEGGED.
- 14. ALL NEW WORKS ARE TO MAKE SMOOTH JUNCTIONS WITH ALL EXISTING CONDITIONS. AC JOINTS TO BE SAW CUT AT CONNECTION TO EXISTING PAVEMENT. THE CONTRACTOR IS TO MAKE ALL DUE ALLOWANCES FOR WORKS DURING CONSTRUCTION.
- 15. SUBSOIL DRAINAGE TO BE PROVIDED BEHIND KERBING AS PER APPROVED PLANS AND AS DIRECTED BY COUNCIL OR THE CERTIFIER DURING CONSTRUCTION.
- 16. THE THICKNESS OF ROAD PAVEMENTS SHALL BE CONFIRMED BY THE CONTRACTOR UPON COMPLETION OF SUBGRADE TESTING UNDERTAKEN BY THE CONTRACTOR.
- 17. SERVICES TO EXISTING DEVELOPMENTS ARE TO BE MAINTAINED AT ALL TIMES.
- 18. PROPOSED SERVICES CROSSING EXISTING ROADS SHALL BE THRUST BORED UNDER THE ROAD SO AS NOT TO DAMAGE EXISTING SURFACES.
- 19. CONTRACTOR IS TO VERIFY THE LOCATION OF ALL EXISTING SERVICES WITH EACH RELEVANT AUTHORITY PRIOR TO COMMENCEMENT OF CONSTRUCTION. ANY DAMAGE TO SERVICES SHALL BE REPAIRED BY THE CONTRACTOR OR THE RELEVANT AUTHORITY AT THE CONTRACTOR'S EXPENSE. SERVICES SHOWN ON THESE PLANS ARE ONLY THOSE EVIDENT AT THE TIME OF SURVEY. ANY UTILITIES ADJUSTMENTS REQUIRED TO BE AT THE CONTRACTORS EXPENSE.
- 20. ENSURE ADEQUATE TRENCH FOUNDATION AND BEDDING COMPACTION SPECIFICALLY ADJACENT TO DRAINAGE STRUCTURES AND PROTECTION TO PIPES FROM CONSTRUCTION TRAFFIC. CRACKED STORMWATER PIPES WILL NOT BE ACCEPTED.
- 21. PROVIDE GALVANISED STEEL KERB OUTLETS PLACED IN KERB ON LOW SIDE OF LOTS, 500mm FROM BOUNDARY OR WHERE SHOWN. PROVIDE SUITABLE ADAPTOR TO ALLOW CONNECTION OF 90mm DIA. S.W.PIPE IN ACCORDANCE WITH COUNCIL STANDARDS
- 22. NO MATERIALS TO BE STOCKPILED ON FUTURE ALLOTMENTS WITHOUT APPROVAL IN WRITING FROM THE CLIENTS REPRESENTATIVE.
- 23. MINIMUM SITE DISTURBANCE AND MAXIMUM VEGETATION AND TREE PRESERVATION TO BE MAINTAINED AT ALL TIMES.
- 24. EROSION AND SILT PROTECTION MEASURES ARE TO BE MAINTAINED AT ALL TIMES AND THE LENGTH OF TRENCH OPENINGS MINIMISED.
- 25. THE CONTRACTORS ITP SHALL ALLOW FOR A HOLD POINT TO ALLOW CHECK LEVELS AND PROOF ROLL PRIOR TO PLACEMENT OF
- SUB BASE COURSE

GALVANISED BOLT DOWN TYPE.

- BASE COURSE MATERIAL WEARING COURSE MATERIAL, PRIME COAT TWO WEEKS PRIOR TO AC SEAL, THICKNESS OF AC SEAL AS SPECIFIED
- 26. ALL PIPES TO BE SOCKET/SPIGOT RUBBER RING JOINT FRC PIPES CLASS '3' OR REINFORCED CONCRETE CLASS '3'. UNLESS NOTED OTHERWISE.
- 27. GRATES TO COMPLY WITH COUNCIL STANDARDS, ALL GRATES TO BE CYCLE FRIENDLY
- 28. STEP IRONS REQUIRED IN PITS GREATER THAN 1.0m DEPTHS.
- 29. THE CONTRACTOR WILL BE RESPONSIBLE FOR THE FULL QA DOCUMENTATION OF THE PROJECT TO ENSURE WORKS MEET THE RELEVANT SECTIONS OF THE CC FOR ROADS AND DRAINAGE WORKS. A COMPLETE ITP PLAN SHALL BE SUBMITTED TO THE SUPERINTENDENT FOR APPROVAL PRIOR TO WORKS COMMENCING ON SITE. COVERING ALL ASPECTS OF THE CONTRACT.

GENERAL NOTES

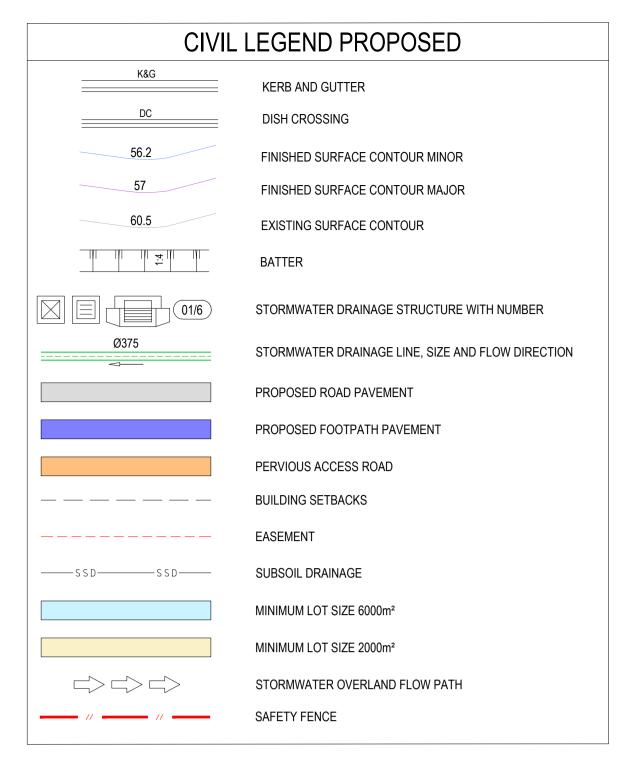
- 30. ALL WORKS ARE TO BE SETOUT BY A REGISTERED SURVEYOR.
- 31. THE CLIENT WILL PREPARE WAE DRAWINGS AT COMPLETION TO ENSURE THE WORKS MEET THE REQUIREMENTS OF THE DESIGN.
- 32. A TRAFFIC CONTROL PLAN IS TO BE SUBMITTED TO COUNCIL BY THE CONTRACTOR FOR APPROVAL PRIOR TO WORKS COMMENCING.
- 33. CONTRACTOR IS TO PROVIDE A 3m LONG LENGTH OF 100Ø SUBSOIL DRAINAGE LINE ON THE UPSTREAM SIDE OF DRAINAGE PITS, INCLUDING GEOFABRIC SOCK AND NOM. 20mm GRAVEL
- 34. ALL DRAINAGE TRENCHES WITHIN THE ROAD RESERVE ARE TO BE BACKFILLED WITH CLEAN SHARP SAND.
- 35. SUB-BASE AND BASE MATERIALS FOR ROADS MUST COMPLY WITH RMS SPECIFICATION 3051. ALL OTHER ROAD PAVEMENT MATERIALS MUST COMPLY WITH THE RELEVANT RMS
- 36. ALL ROADS ARE TO HAVE A TEMPORARY SINGLE COAT SEAL APPLIED PRIOR TO LAYING OF THE ASPHALTIC CONCRETE SEAL. AC TO BE BONDED.
- 37. POWER & LIGHT POLES TO HAVE A 1m X 1m ISOLATION ZONE REGARDLESS OF LOCATION.
- 38. ALL INTER-ALLOTMENT PIPELINES TO HAVING RODDING EYES IMMEDIATELY DOWNSTREAM OF ALL SLOPE JUNCTIONS.
- 39. CONCRETE PATHS, DRIVEWAYS, & BATTLE-AXE HANDLES TO BE BONDED PENDING COMPLETION OF SERVICES IN ACCORDANCE WITH COUNCIL REQUIREMENTS AND AS DIRECTED BY THE PRINCIPAL
- 40. ALL MAJOR & NON-STANDARD STRUCTURES TO HAVE ENGINEERING CERTIFICATION.
- 41. HIGH EROSION AREAS, INCLUDING BATTERS TO BE STABILISED WITHIN 7 DAYS OF COMPLETION OF WORKS AND EARLIER IF DIRECTED BY THE SUPERINTENDENT.
- 42. ALL STABILISED WORKS ARE TO BE MAINTAINED UNTIL EXPIRY OF MAINTENANCE PERIOD.
- 43. ALL STRABILISED WORKS ARE TO BE MAINTAINED UNTIL EXPIRY OF MAINTENANCE PERIOD. OVERFLOW PATHS TO BE FORMED AT THE TIME OF CONSTRUCTION TO SUIT DESIGN ARI
- 44. VARIATIONS NEED TO BE APPROVED PRIOR TO COMMENCEMENT OF WORK. IF IN DOUBT, CONTACT ACOR CONSULTANTS

EARTHWORKS NOTES

- EARTHWORKS TO BE CARRIED OUT TO THE SATISFACTION OF COUNCIL'S AND RELEVANT AUSTRALIAN STANDARD AND GEOTECH ENGINEER. UNSOUND MATERIALS ARE TO BE REMOVED FROM ROADS AND LOTS AND TESTED PRIOR TO FILLING. THE CONTRACTOR IS TO PROVIDE PLANS OF TEST LOCATIONS AND TEST CERTIFICATES AS PER THE SPECIFICATION WHERE REQUIRED. THE CONTRACTOR MUST ENSURE COUNCIL APPROVAL OF MATERIALS, PRIOR TO DELIVERY TO SITE.
- DEWATER AND REMOVE SLUDGE FROM EXISTING DAM ENSURE ALL DAM DEWATERING AND SLUDGE REMOVAL IS IN ACCORDANCE WITH SEPARATE REPORT BY OTHERS.
- 3. ALL EARTHWORKS TO BE APPROVED BY A GEOTECHNICAL ENGINEER TO LEVEL 1 MONITORING, SAMPLING, TESTING AND CERTIFICATION.
- 4. TOPSOIL FROM SITE FILLING AND REGRADING AREAS TO BE STRIPPED, STOCKPILED AND RESPREAD AS SHOWN ON PLAN. EXCESS MATERIAL TO BE CARTED OFFSITE TO APPROVED LOCATION. ALL SITE FILLING TO BE COMPACTED IN ACCORDANCE WITH AS3798 TO A MIN. OF 98% SMDD AT ±2% OF O.M.C. A GEOTECHNICAL CERTIFICATE FROM A N.A.T.A REGISTERED LABORATORY IS TO BE SUPPLIED BY CONTRACTOR.
- WHERE THE SLOPE OF THE NATURAL SURFACE EXCEEDS ONE IN FOUR (1:4) BENCHES ARE TO BE CUT TO PREVENT SLIPPING OF THE PLACED FILL MATERIAL AS REQUIRED BY THE DEVELOPER'S GEOTECH ENGINEER TO STANDARD PRACTICE.
- 6. ALL BATTERS ARE TO SCARIFIED TO ASSIST WITH ADHESION OF TOP SOIL TO BATTER FACE.
- PROVIDE MIN. 50mm 75mm TOPSOIL WITH COUCH GRASS TURF ON ALL FOOTPATHS. ALL BARE AREAS OTHER THAN FOOTPATHS TO BE SOWN WITH SEED, FERTILISED AND HAY MULCHED TO COUNCIL'S SPECIFICATION. GRASS / TURF TO BE MAINTAINED BY CONTRACTOR AT ALL TIMES INCLUDING PERIODS OF INSUFFICIENT RAIN.
- 8. THE CONTROL TESTING OF EARTHWORKS SHALL BE IN ACCORDANCE WITH THE GUIDELINES IN AUSTRALIAN STANDARD 3798-1990. WHERE IT IS PROPOSED TO USED TEST METHOD AS1289 EB.1 OR AS1289 EB2 TO DETERMINE THE FIELD DENSITY, A SAND REPLACEMENT METHOD SHALL BE USED TO CONFIRM THE RESULTS AS DIRECTED BY COUNCIL.
- 9. THE CONTRACTOR SHALL CONTROL SEDIMENTATION, EROSION AND POLLUTION DURING CONSTRUCTION IN ACCORDANCE WITH THE REQUIREMENTS OF COUNCIL AND APPROVED
- 10. A 1.2 METER WIDE, CONTINUOUS STRIP OF COUCH GRASS SHALL BE PLACED BEHIND THE BACK OF ALL KERBS AND PERIMETER OF ALL INLET PITS IMMEDIATELY AFTER THE COMPLETION OF THE FOOTPATH GRADING AND CONSTRUCTION OF PITS RESPECTIVELY, MAINTAINED AND REPLACED AS REQUIRED DURING THE MAINTENANCE PERIOD. TURFING / LANDSCAPE GRASS SHALL ALSO BE PLACED TO THE FULL WIDTH OF ROAD SWALE DRAINS UPON COMPLETION.
- 11. SOIL AND SEDIMENT PROTECTION TO BE PROVIDED AND THOROUGHLY MAINTAINED AROUND DRAINAGE SYSTEM FOR THE DURATION OF WORKS. DIVERSION OF WATER AND THE PROTECTION OF WORKS IS THE CONTRACTORS RESPONSIBILITY.
- 12. LOTS REQUIRING FILL SHALL BE CONSTRUCTED TO LEVEL 1 SUPERVISION WITH TESTING AND DOCUMENTATION SUITABLE TO DETERMINE FUTURE LOT CLASSIFICATION.
- 13. CONTROLLED EARTHWORKS SHALL BE CERTIFIED BY A N.A.T.A REGISTERED LABROITORY. ALL TEST CERTIFICATION AND PLANS LOCATION TO BE SUBMITTED TO THE PRINCIPAL AND SHALL BE TO COUNCILS SATISFACTION

IMPORTANT NOTES

- REFER TO PENRITH CITY COUNCIL STANDARD DRAWINGS FOR DETAILS OF THE FOLLOWING
- STANDARD KERB & GUTTER, LAYBACKS & DISH CROSSING SHEET 1of2 SD.1003/1
- STANDARD KERB & GUTTER, LAYBACKS & DISH CROSSING SHEET 2of2 SD.1003/2
- STANDARD FOOTPATH DETAIL SD.1001
- **VEHICULAR CROSSING, REFER TO DRAWING SD.1004**



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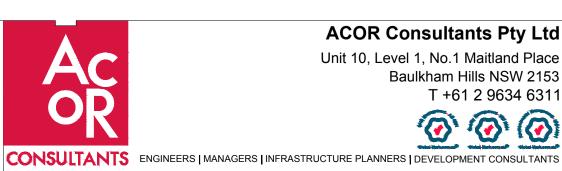
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ISSUE FOR DEVELOPMENT APPLICATION 17.10.22 UF VG ISSUE FOR DEVELOPMENT APPLICATION 11.10.22 UF VG ISSUE FOR COORDINATION 14.09.22 UF VG Date Drawn Approved Issue Description

PENRITH 601 HIGH STREET CITY COUNCIL PENRITH, NSW 2750 PHONE: (02) 4732 7777

LEVEL 10, 70 PITT STREET SYDNEY, NSW 2000 PHONE: (02) 9249 4100






ACOR Consultants Pty Ltd | Project Baulkham Hills NSW 2153 T +61 2 9634 6311

Unit 10, Level 1, No.1 Maitland Place | EMU PLAINS INDUSTRIAL PARK

158-164 OLD BATHURST ROAD EMU PLAINS, NSW 2750

NOT FOR CONSTRUCTION NOTES AND LEGENDS

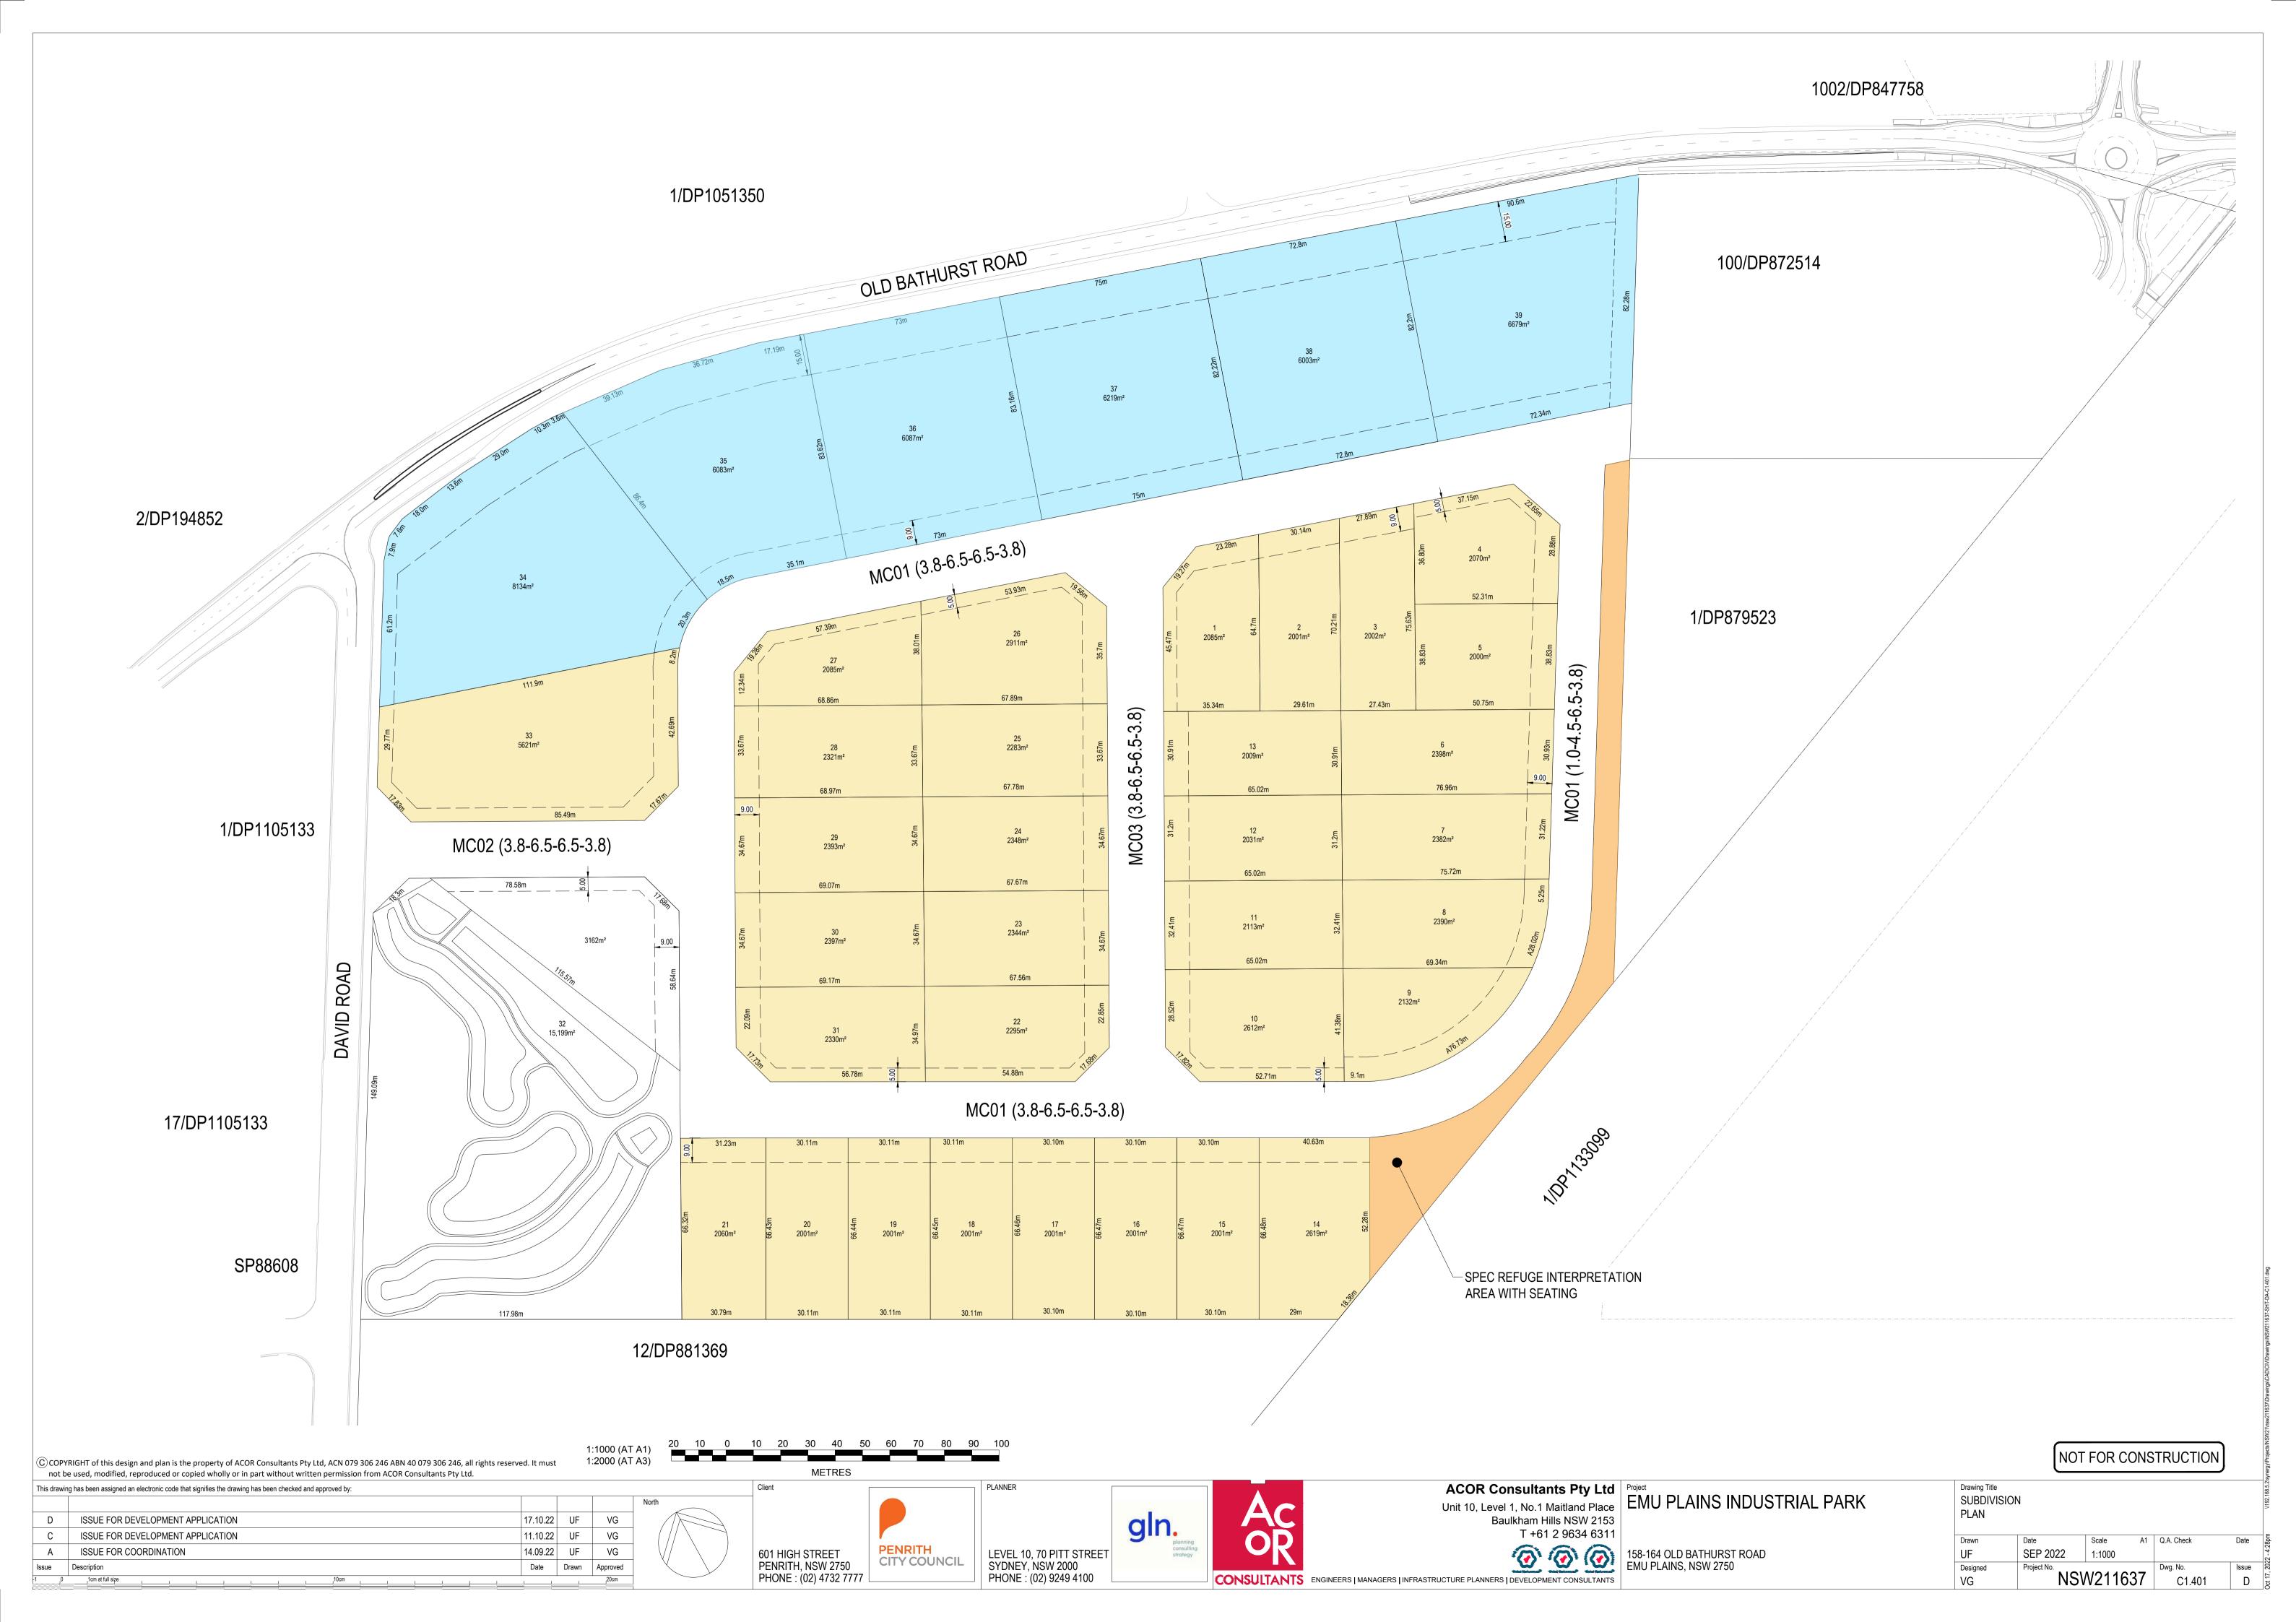A1 Q.A. Check Scale UF SEP 2022 NOT TO SCALE Designed NSW211637 VG C1.101



LEGEND

DISTURBED AREA

DISTURBED AREA

TREE TO BE RETAINED (326)

102 TREE TO BE REMOVED (400)

NOTE:

 COORDINATION WITH GROUP GSA AND CIVICA

TREE	93	284	373	478	592	650
TAG No.	102	285	374	479	593	651
1	104	286	375	480	594	652
2	105	287	376	481	595	653
3	106	288	377	482	596	654
4	108	289	378	483	597	655
5	112	290	379	484	598	656
6	118	291	380	485	599	657
7	122	292	381	486	600	658
8	183	293	382	488	601	659
9	184	294	383	495	602	660
10	210	295	384	503	603	661
11	219	296	385	504	604	662
12	220	297	386	505	605	663
13	231	298	387	506	606	664
14	235	299	388	507	607	665
15	235	300	389	508	608	666
16	236	301	390	509	609	667
17	237	302	391	510	610	668
18	239	303	392	511	611	669
19	241	304	393	512	612	670
20	242	305	394	513	613	671
21	243	308	395	514	614	672
22	244	310	396	515	615	673
23	245	313	397	516	616	674
24	246	314	398	517	617	675
25	247	315	399	518	618	676
26	248	325	400	519	619	677
27	249	329	401	520	620	678
28	250	330	402	522	621	679
29	251	334	403	523	622	690
30	252	336	404	524	623	691
31	253	337	405	529	624	692
32	254	340	406	531	625	693
33	255	341	407	535	626	694
34	256	349	408	538	627	695
35	257	350	409	551	628	696
36	258	352	410	571	629	697
37	260	353	411	572	630	698
38	265	354	412	573	631	699
39	266	355	413	574	632	700
40	267	356	414	575	633	701
41	268	357	415	576	634	702
42	269	358	416	577	635	703
43	270	359	417	578	636	704
44	271	360	418	579	637	705
48	272	361	419	580	638	706
52	273	362	427	581	639	707
57	274	363	463	582	640	708
58	275	364	466	583	641	709
59	276	365	469	584	642	722
60	277	366	471	585	643	721
61	278	367	472	586	644	722
62	279	368	473	587	645	723
63	280	369	474	588	646	724
64	281	370	475	589	647	726
81	282	371	476	590	648	
<u> </u>	283	372	477	591	649	

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17.10.22 UF

11.10.22 UF

14.09.22 UF

Date Drawn Approved

VG

VG

VG

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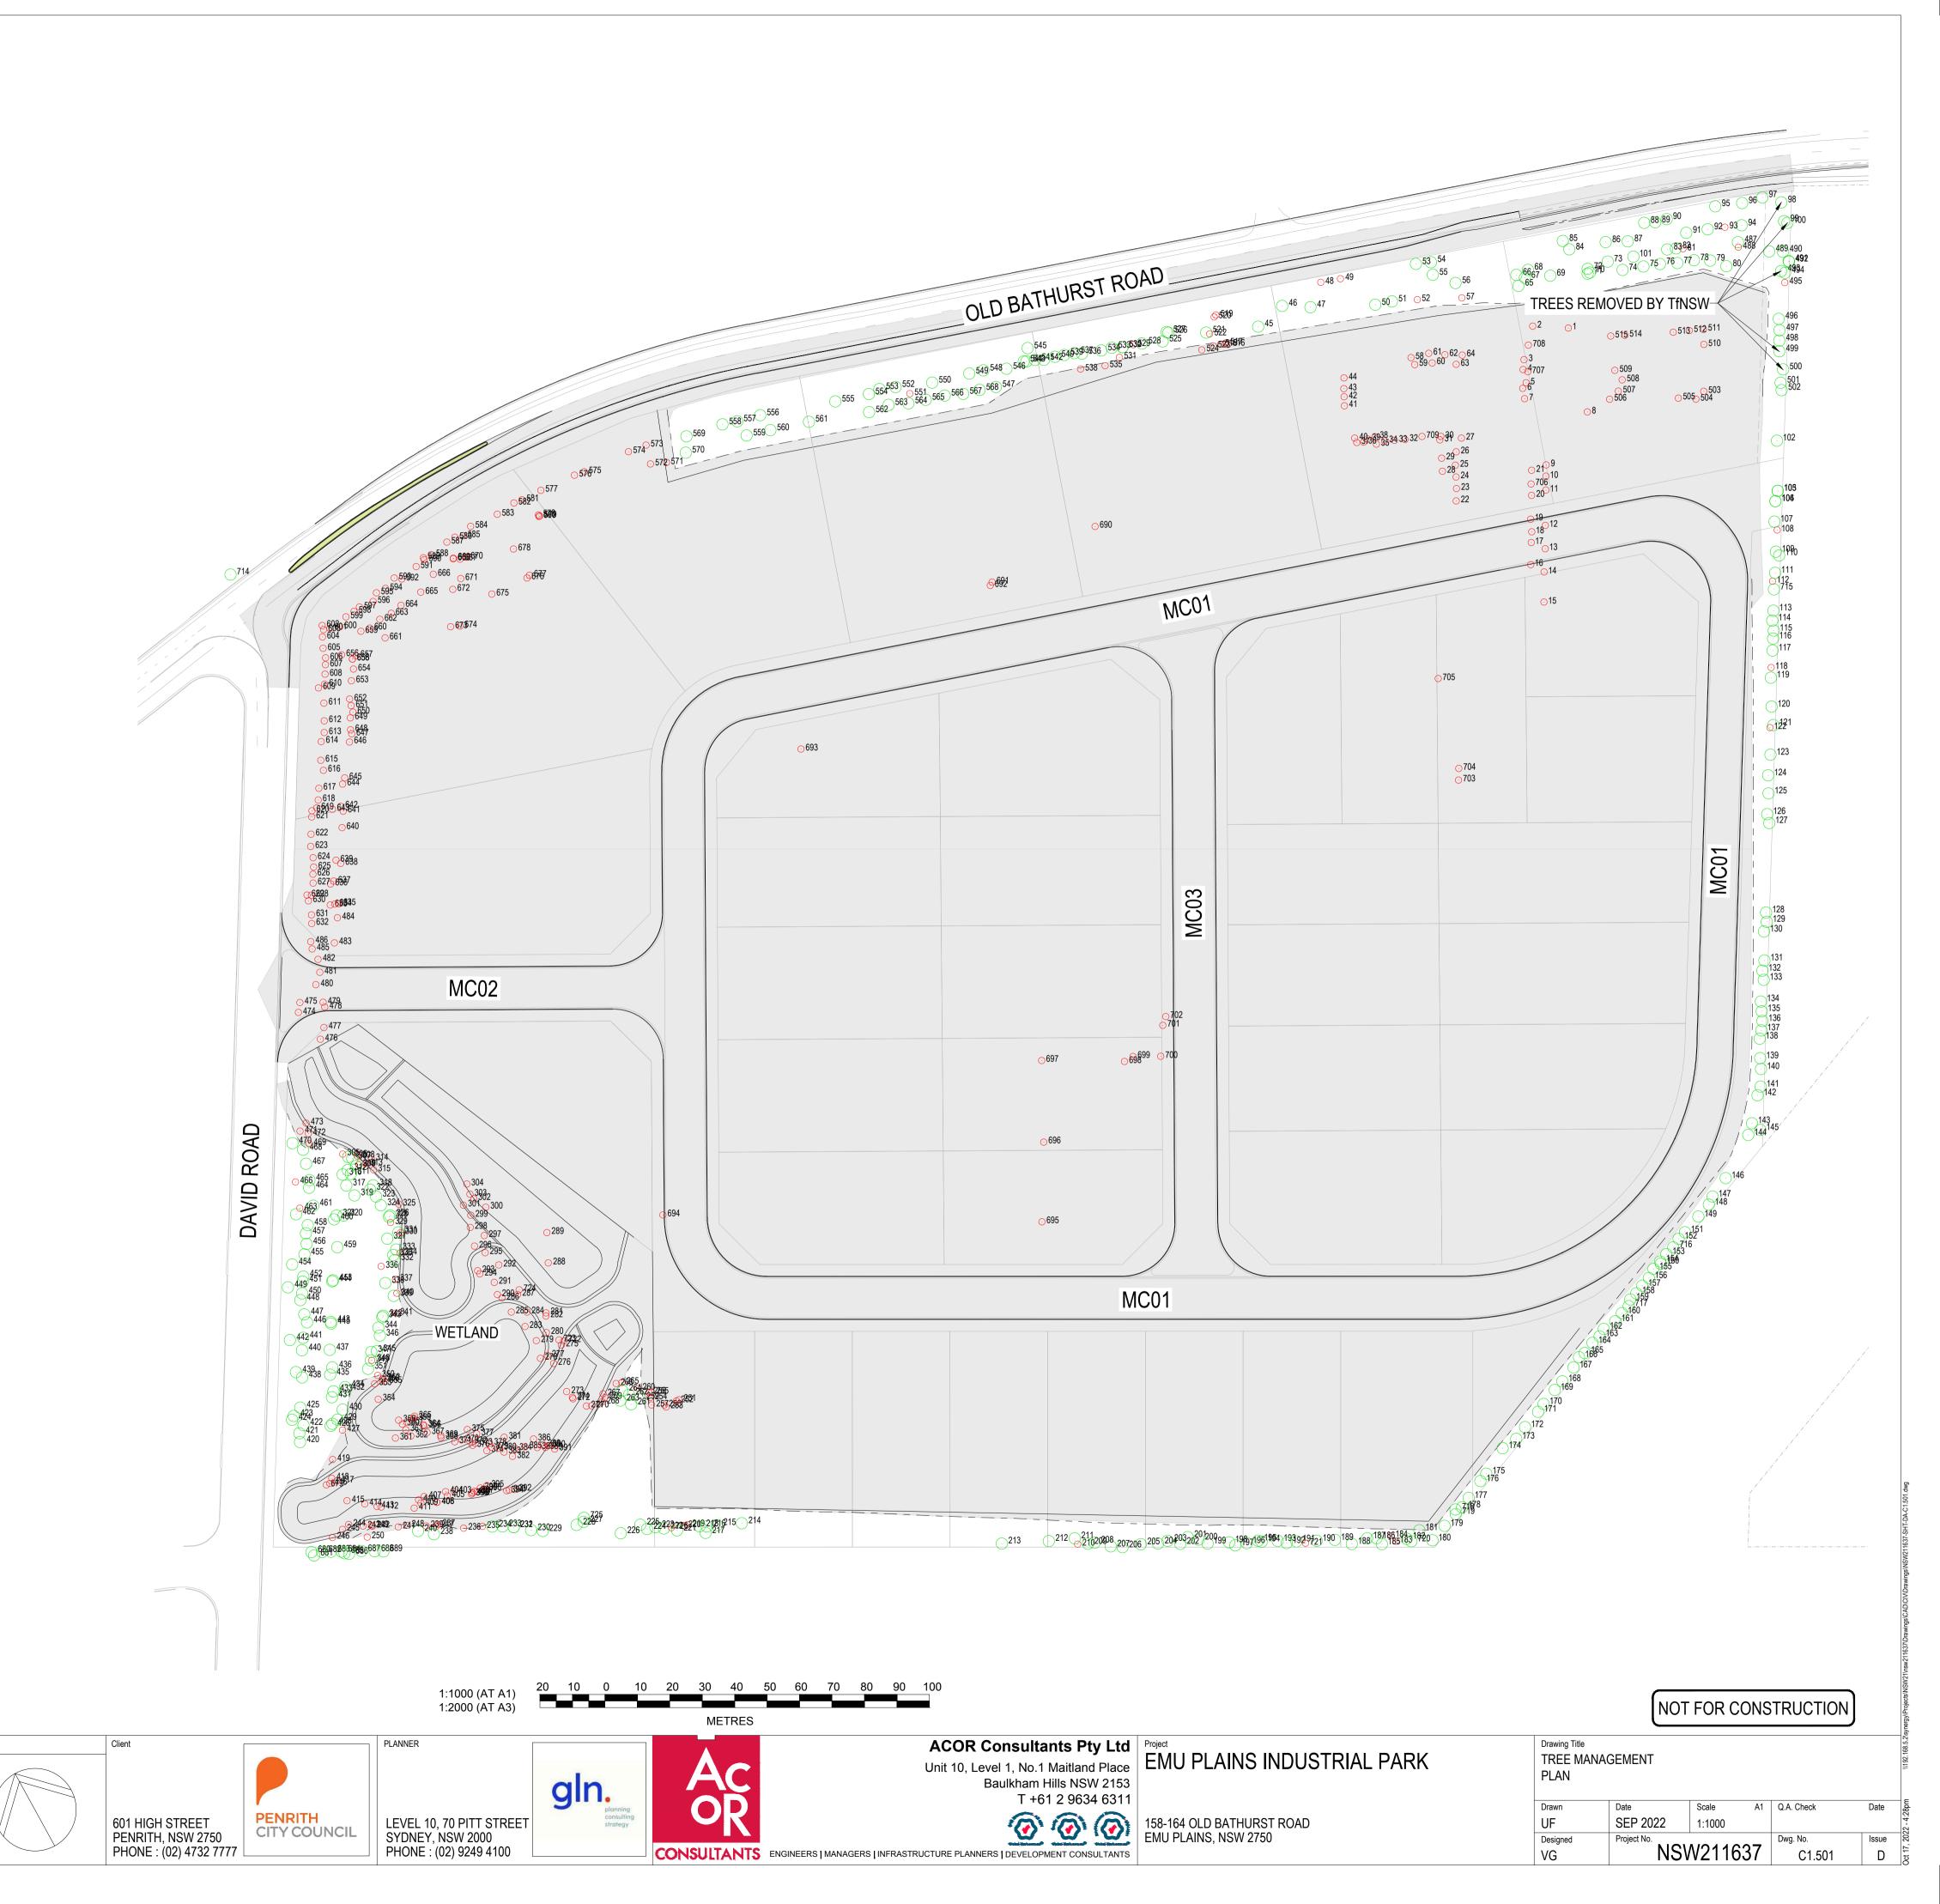
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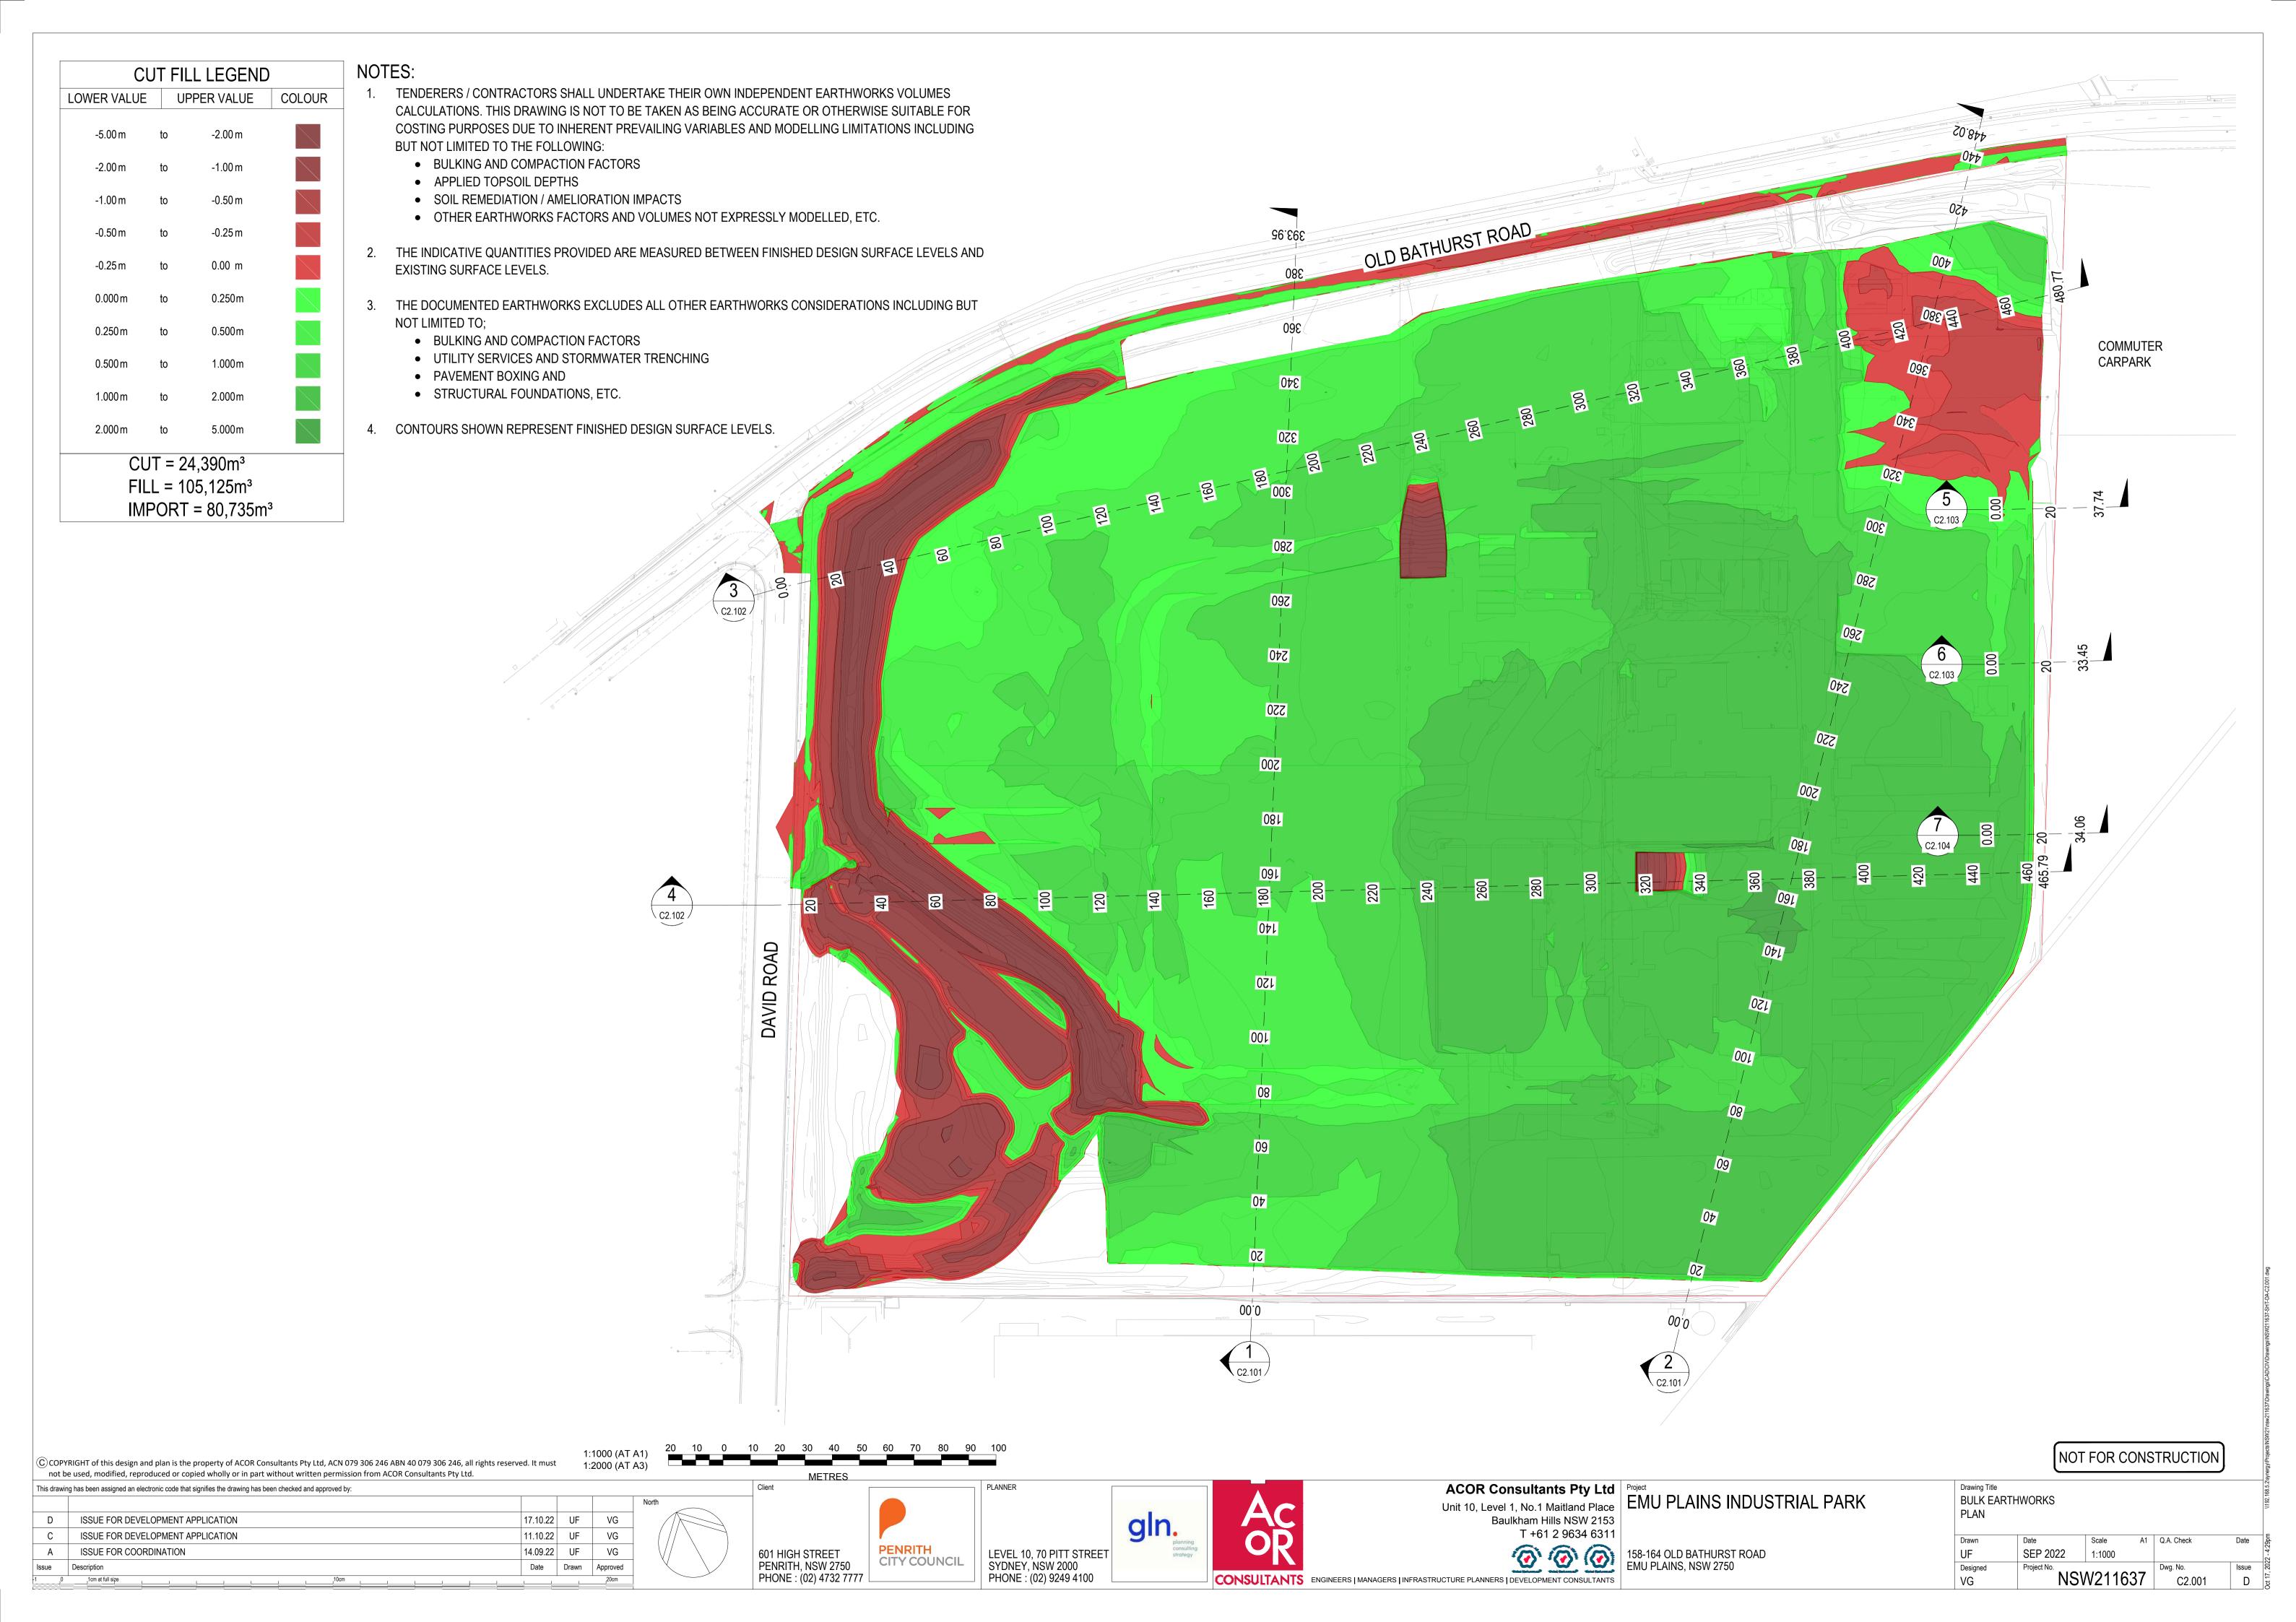
ISSUE FOR DEVELOPMENT APPLICATION


ISSUE FOR DEVELOPMENT APPLICATION

ISSUE FOR COORDINATION

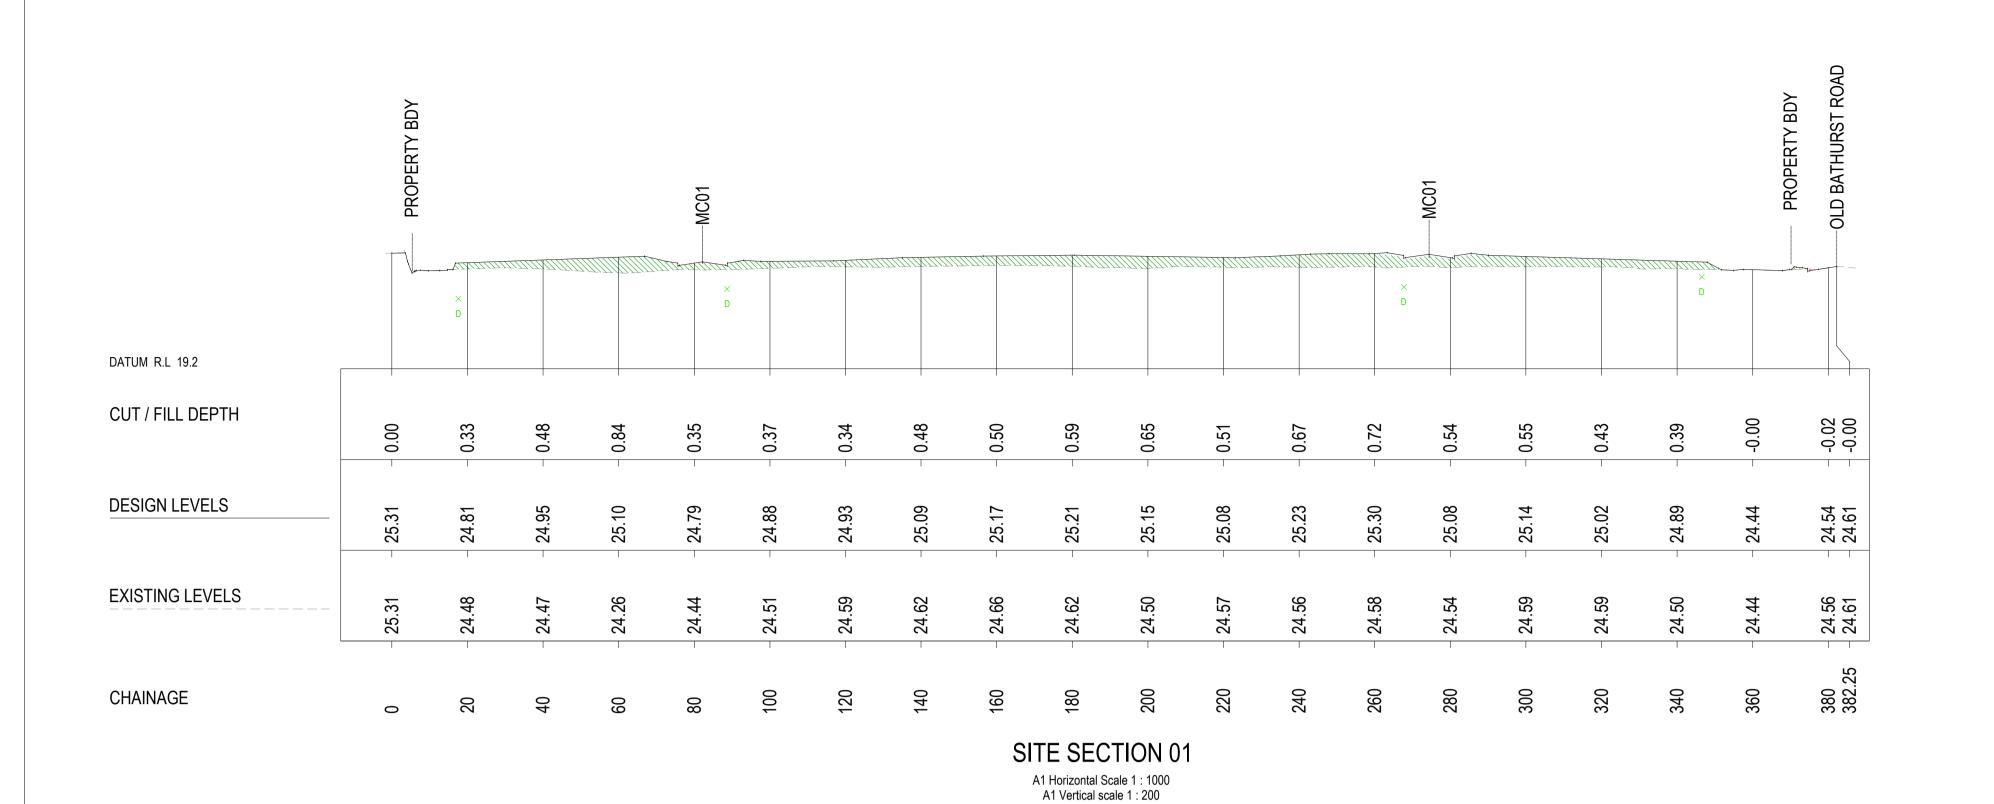Issue Description







PROPERTY BDY -MC01 OLD DATUM R.L 18.3 CUT / FILL DEPTH -0.06 0.01 **DESIGN LEVELS** 23.52 23.78 **EXISTING LEVELS** 23.58 23.78 CHAINAGE SITE SECTION 02

1:1000 (AT A1) V 1:200 (AT A1) 1:2000 (AT A3) © COPYRIGHT of this design and plan is the property of ACOR Consultants Pty Ltd, ACN 079 306 246 ABN 40 079 306 246, all rights reserved. It must **METRES METRES** not be used, modified, reproduced or copied wholly or in part without written permission from ACOR Consultants Pty Ltd.

PLANNER

ACOR Consultants Pty Ltd
Unit 10, Level 1, No.1 Maitland Place

Project
EMU PLAINS INDUSTRIAL PARK Baulkham Hills NSW 2153

BULK EARTHWORKS SECTIONS SECTION 01 - 02

LEGEND

PROPOSED CUT

PROPOSED FILL

Scale A1 Q.A. Check SEP 2022 AS SHOWN UF Designed NSW211637 C2.101

NOT FOR CONSTRUCTION

	<u> </u>				
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					North
D	ISSUE FOR DEVELOPMENT APPLICATION	17.10.22	UF	VG	
С	ISSUE FOR DEVELOPMENT APPLICATION	11.10.22	UF	VG	
Α	ISSUE FOR COORDINATION	14.09.22	UF	VG	
Issue	Description	Date	Drawn	Approved	
-1 _0	1cm at full size			20cm	

Client 601 HIGH STREET PENRITH, NSW 2750 PHONE : (02) 4732 7777 **PENRITH** CITY COUNCIL

A1 Horizontal Scale 1 : 1000 A1 Vertical scale 1 : 200

LEVEL 10, 70 PITT STREET SYDNEY, NSW 2000 PHONE: (02) 9249 4100

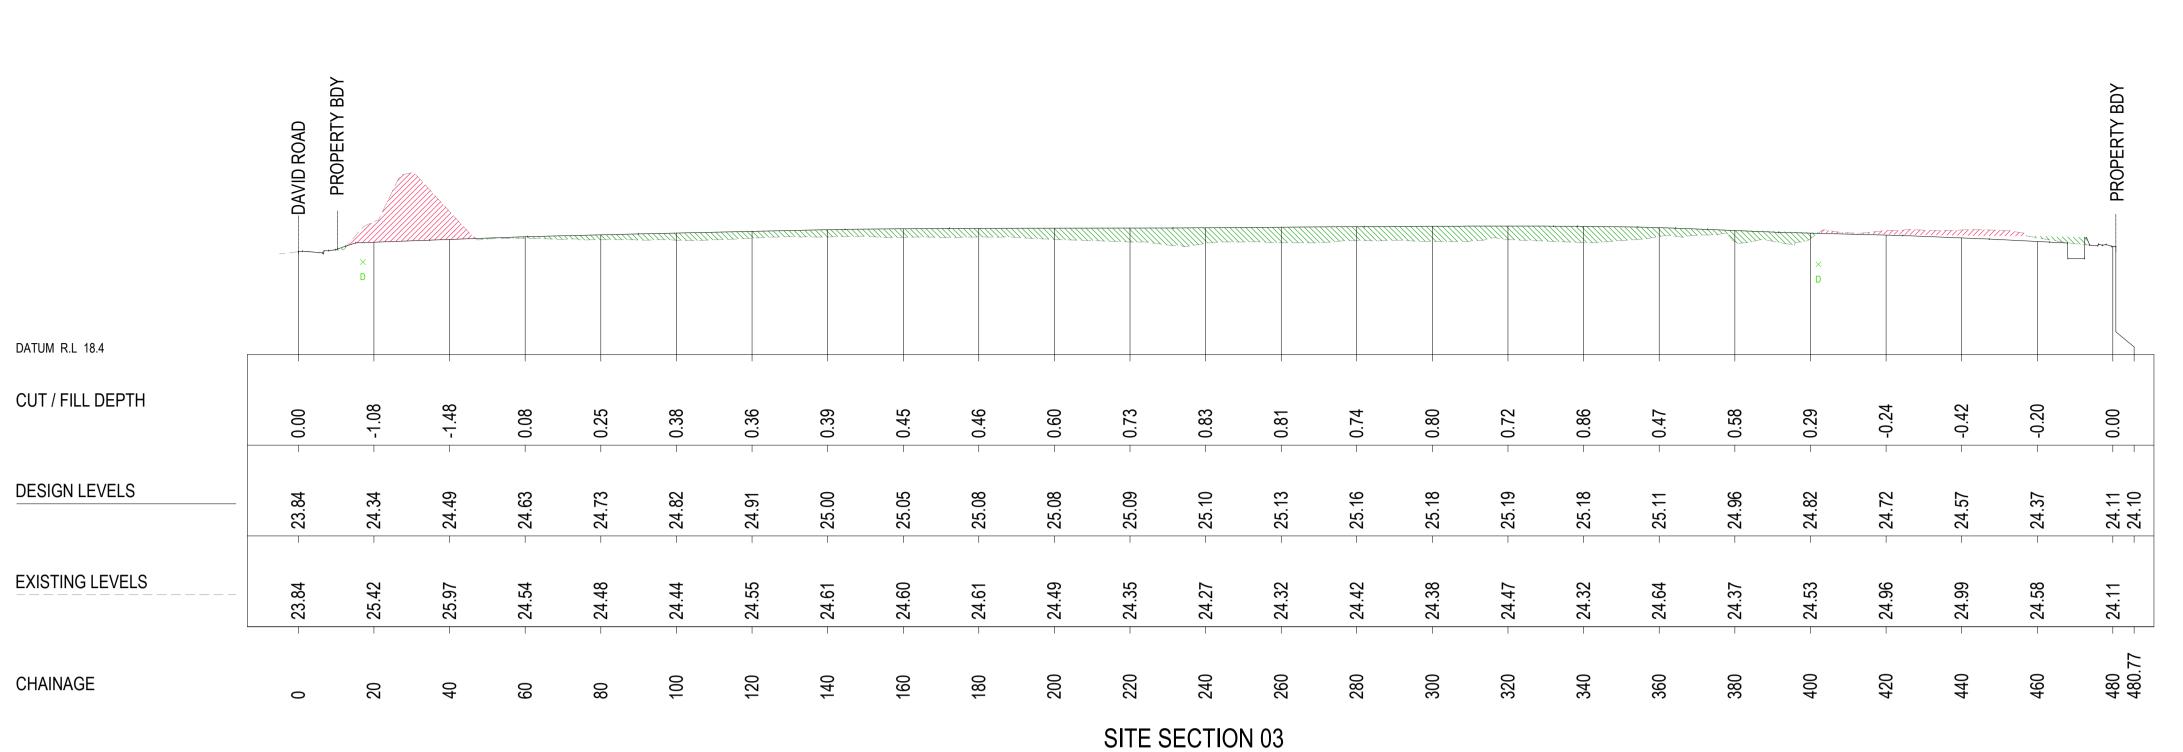







158-164 OLD BATHURST ROAD EMU PLAINS, NSW 2750

T +61 2 9634 6311



LEGEND PROPOSED CUT PROPOSED FILL

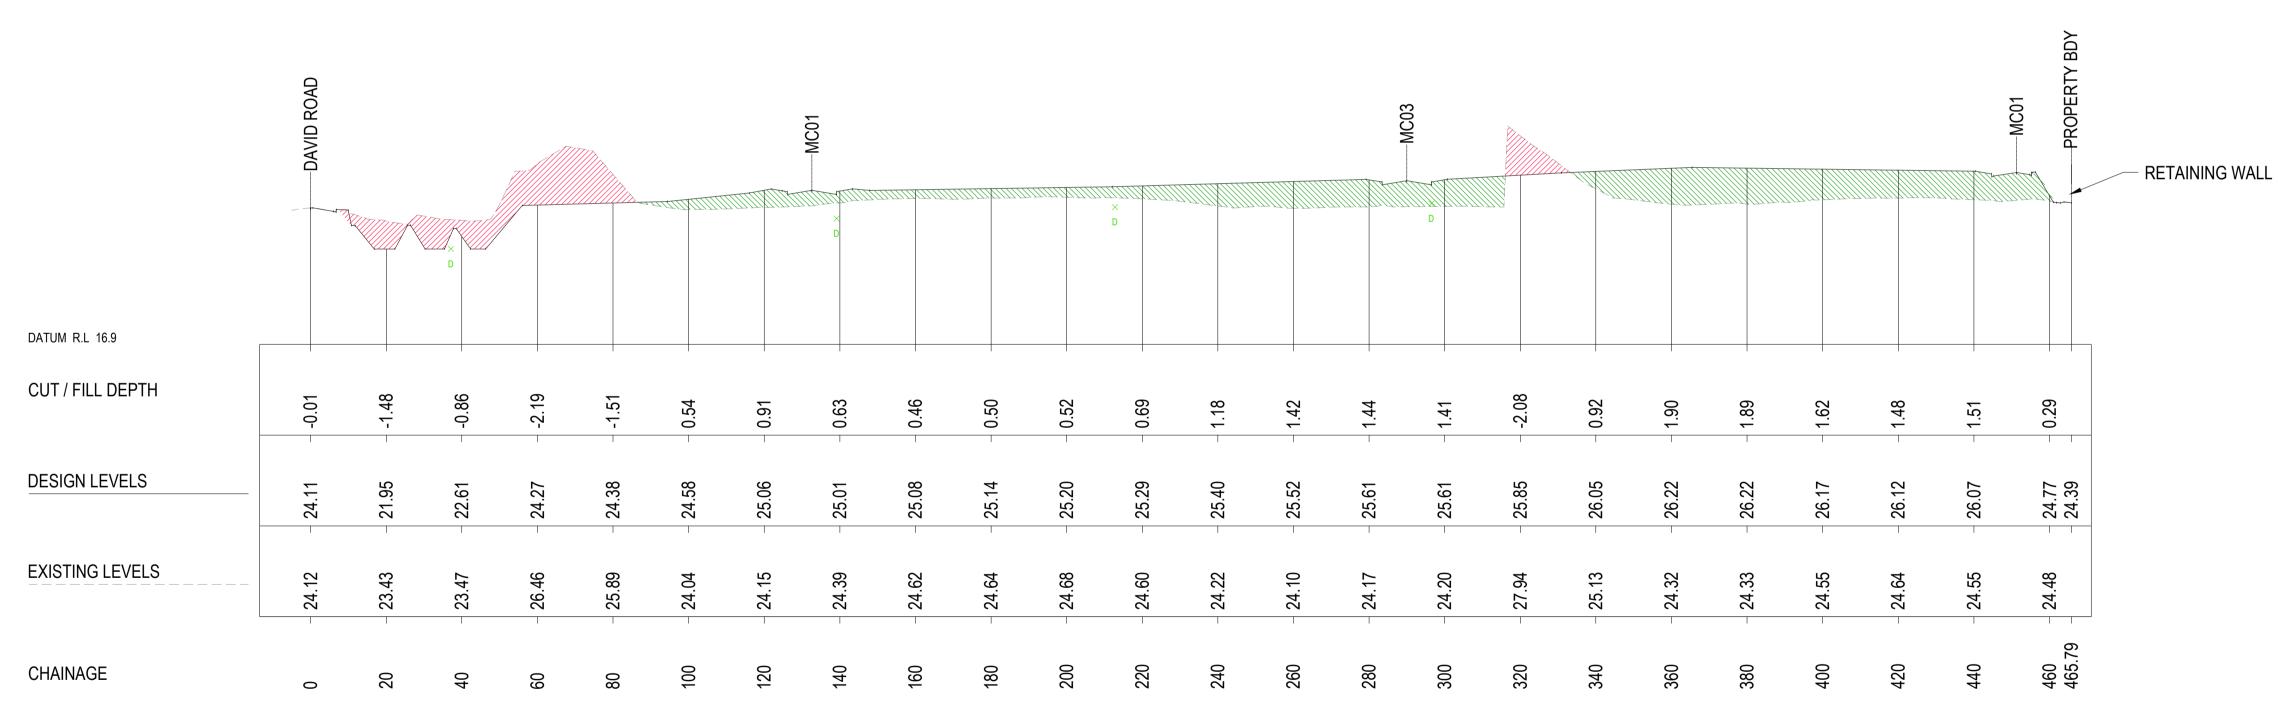A1 Horizontal Scale 1 : 1000 A1 Vertical scale 1 : 200



SITE SECTION 04 A1 Horizontal Scale 1 : 1000 A1 Vertical scale 1 : 200



Baulkham Hills NSW 2153 T +61 2 9634 6311

ACOR Consultants Pty Ltd
Unit 10, Level 1, No.1 Maitland Place

Project
EMU PLAINS INDUSTRIAL PARK

BULK EARTHWORKS SECTIONS SECTION 03 - 04

Drawn	Date	Scale	A1	Q.A. Check	Date
UF	SEP 2022	AS SHOWN			
Designed	Project No.		_	Dwg. No.	Issue
VG	NSV	V21163	3/	C2.102	D

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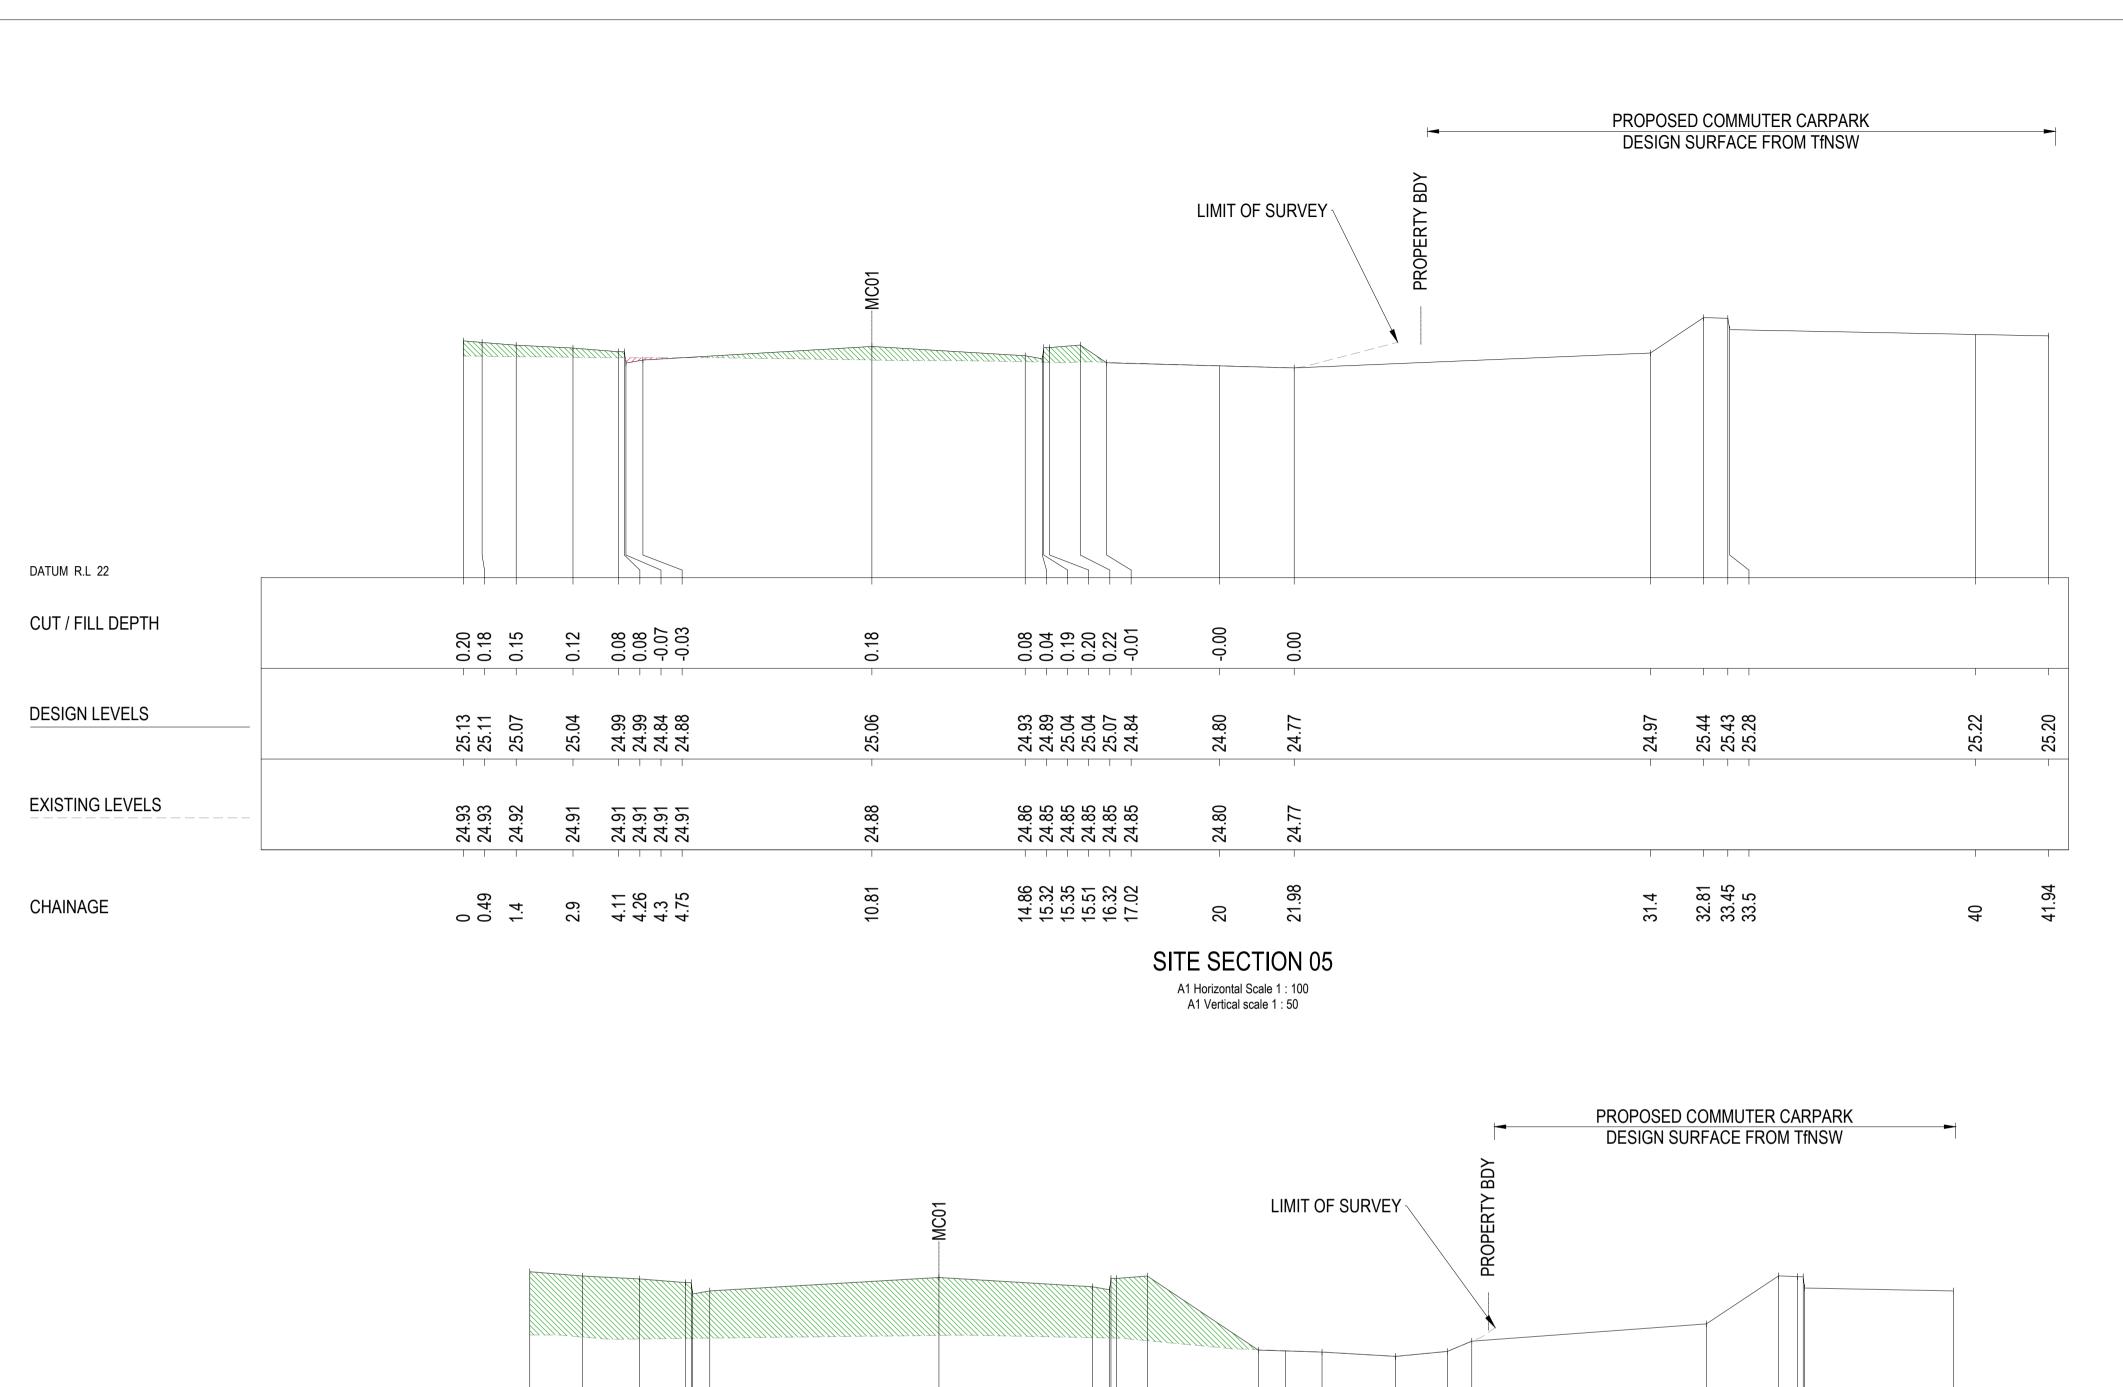
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D	ISSUE FOR DEVELOPMENT APPLICATION	17.10.22	UF	VG	
С	ISSUE FOR DEVELOPMENT APPLICATION	11.10.22	UF	VG	
Α	ISSUE FOR COORDINATION	14.09.22	UF	VG	
Issue	Description	Date	Drawn	Approved	








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CITY COUNCIL

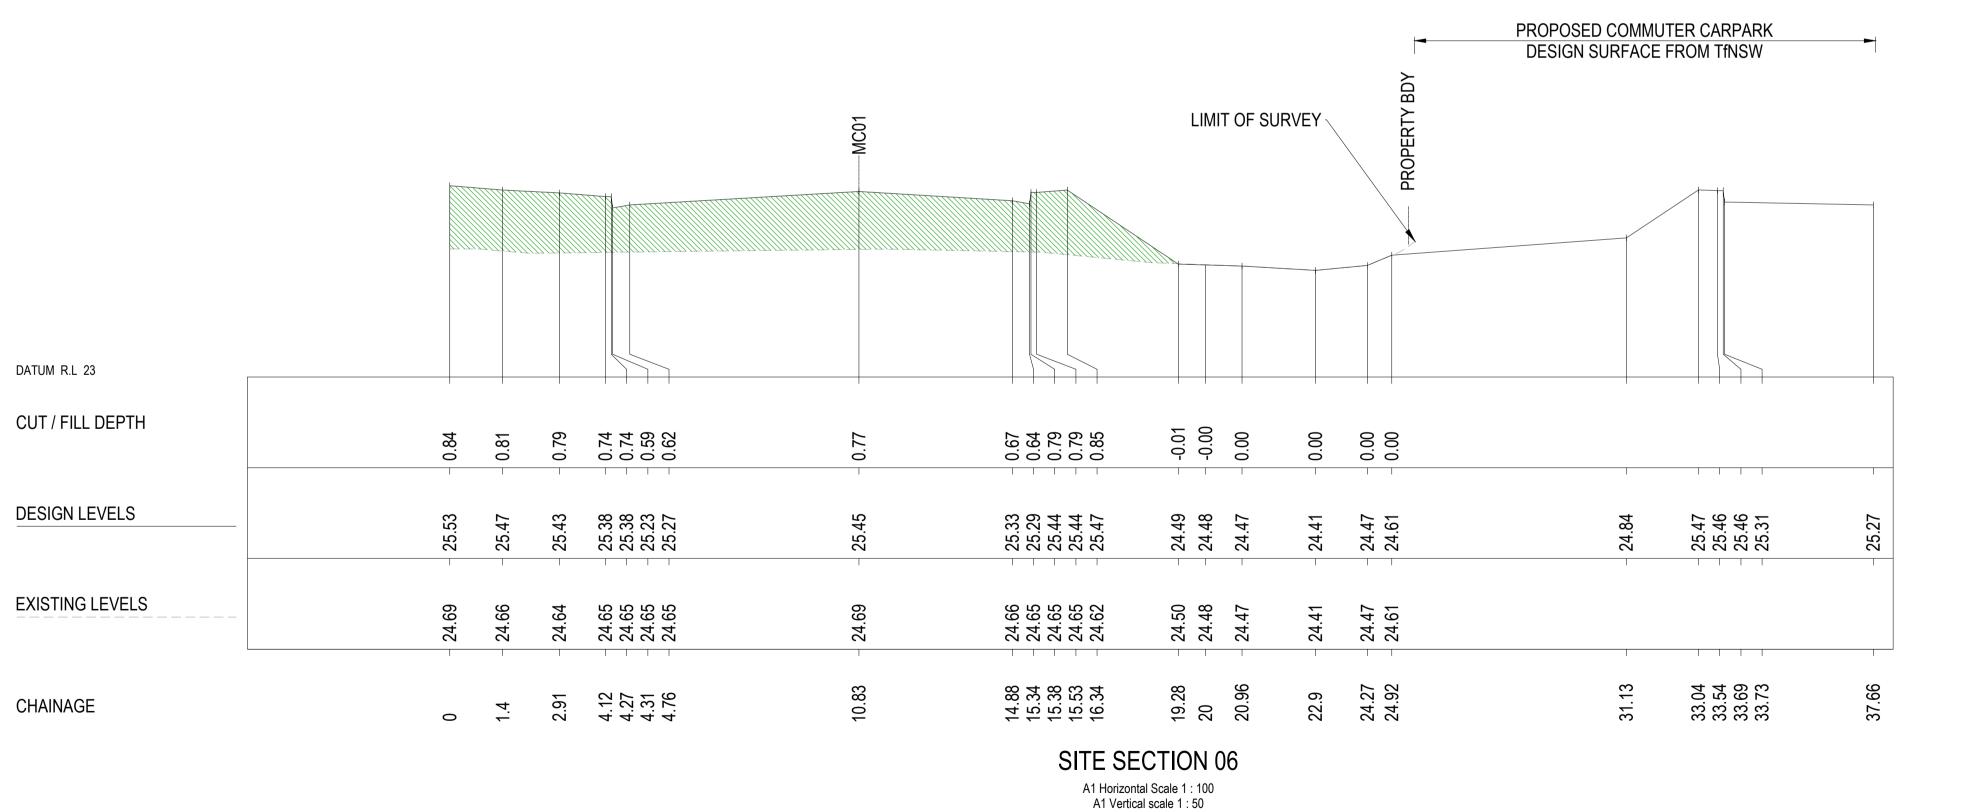gln. LEVEL 10, 70 PITT STREET SYDNEY, NSW 2000 PHONE : (02) 9249 4100

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ACOR Consultants Pty Ltd
Unit 10, Level 1, No.1 Maitland Place

Project
EMU PLAINS INDUSTRIAL PARK Baulkham Hills NSW 2153

T +61 2 9634 6311 158-164 OLD BATHURST ROAD EMU PLAINS, NSW 2750

NOT FOR CONSTRUCTION

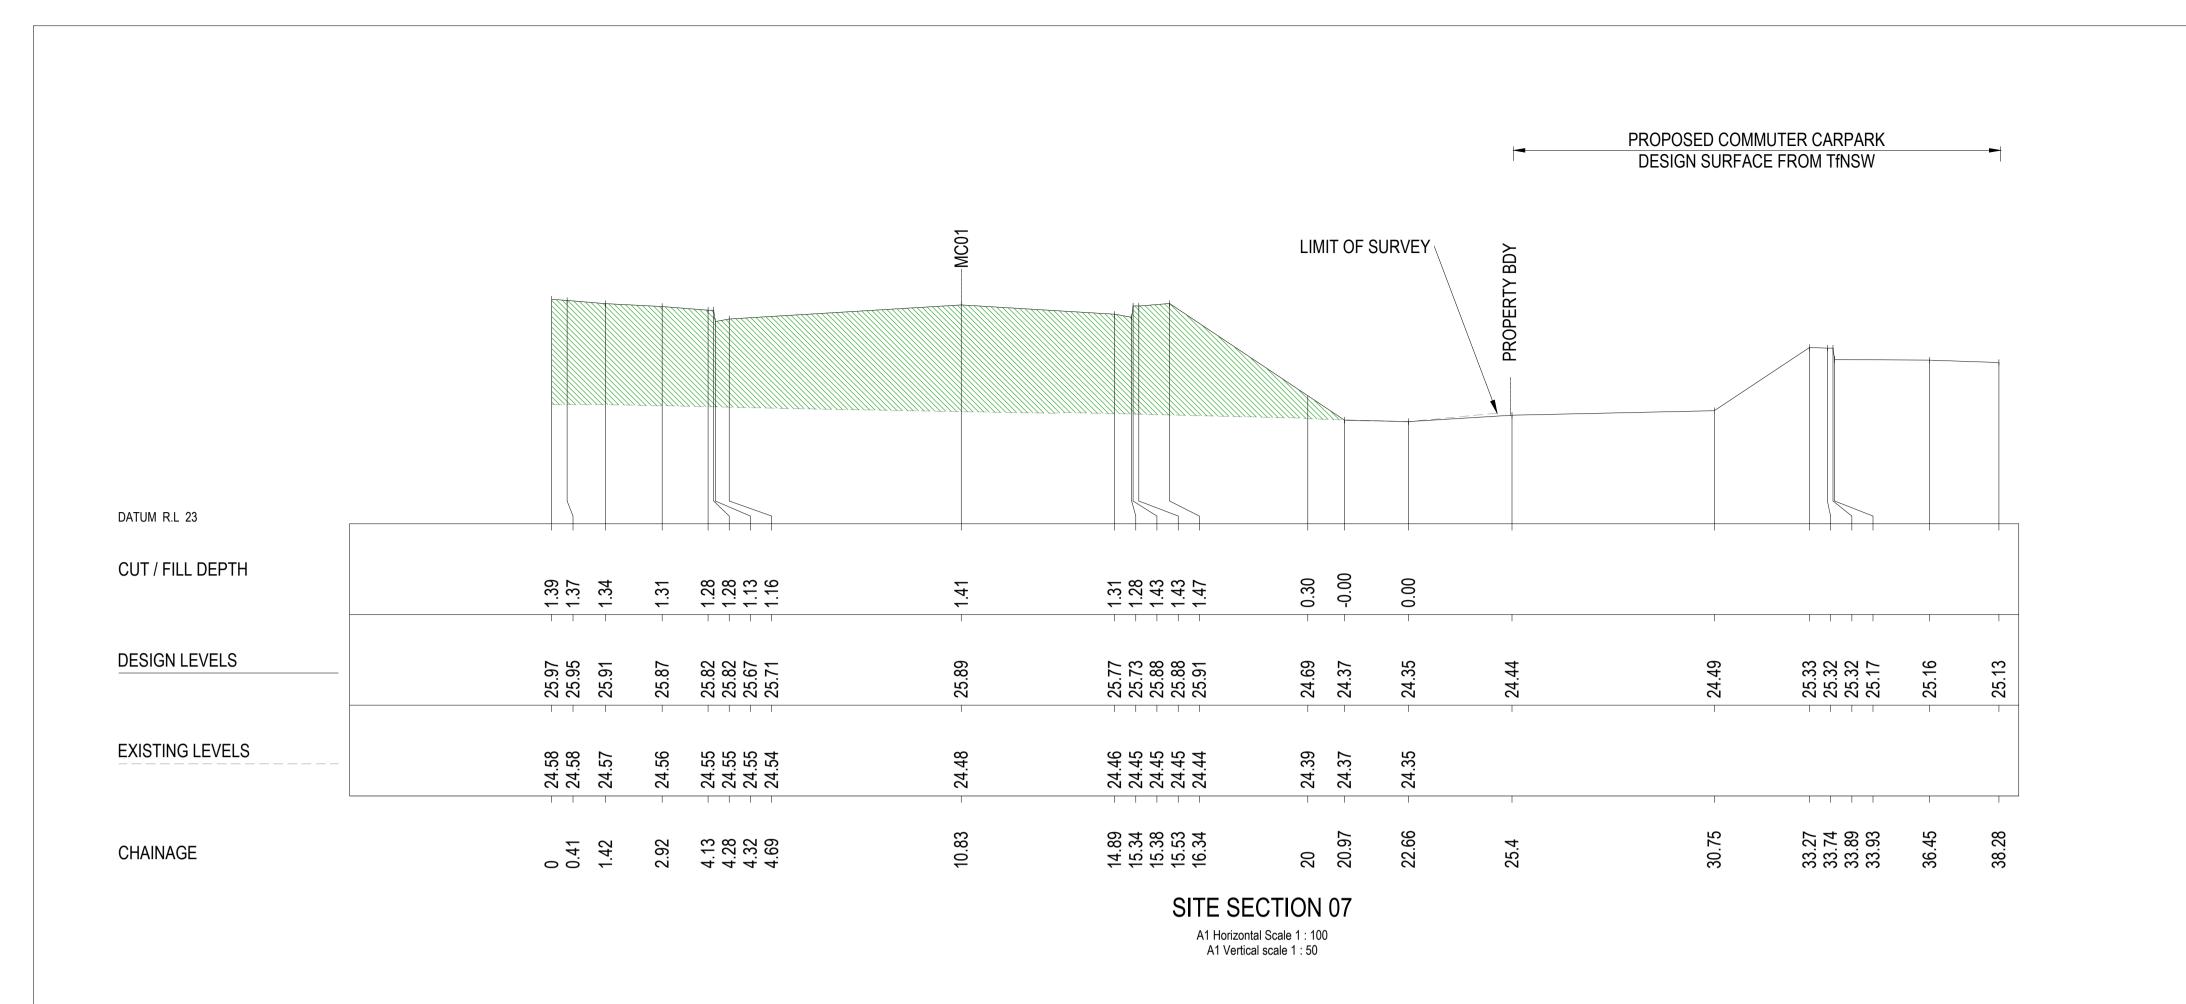
BULK EARTHWORKS SECTIONS SECTION 05 - 06

Scale A1 Q.A. Check SEP 2022 AS SHOWN UF Designed NSW211637 VG C2.103

LEGEND

PROPOSED CUT

PROPOSED FILL



NOT FOR CONSTRUCTION

Unit 10, Level 1, No.1 Maitland Place
Baulkham Hills NSW 2153

Project

EMU PLAINS INDUSTRIAL PARK T +61 2 9634 6311

158-164 OLD BATHURST ROAD EMU PLAINS, NSW 2750


BULK EARTHWORKS SECTIONS SECTION 07

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UF	SEP 2022	AS SHOWN				
Designed	Project No.			Dwg. No.	Issue	, 2022
VG	NSV	V21163	37	C2.104	D	Oct 17

LEGEND

PROPOSED CUT

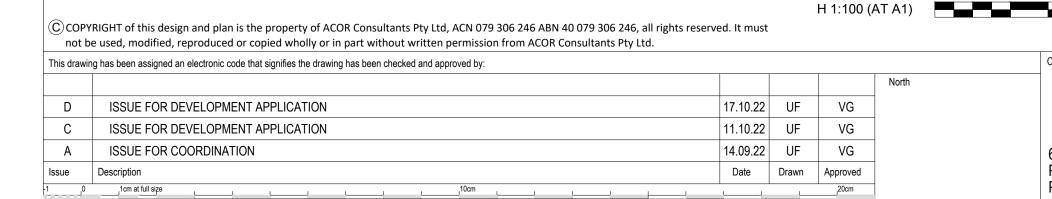PROPOSED FILL





METRES



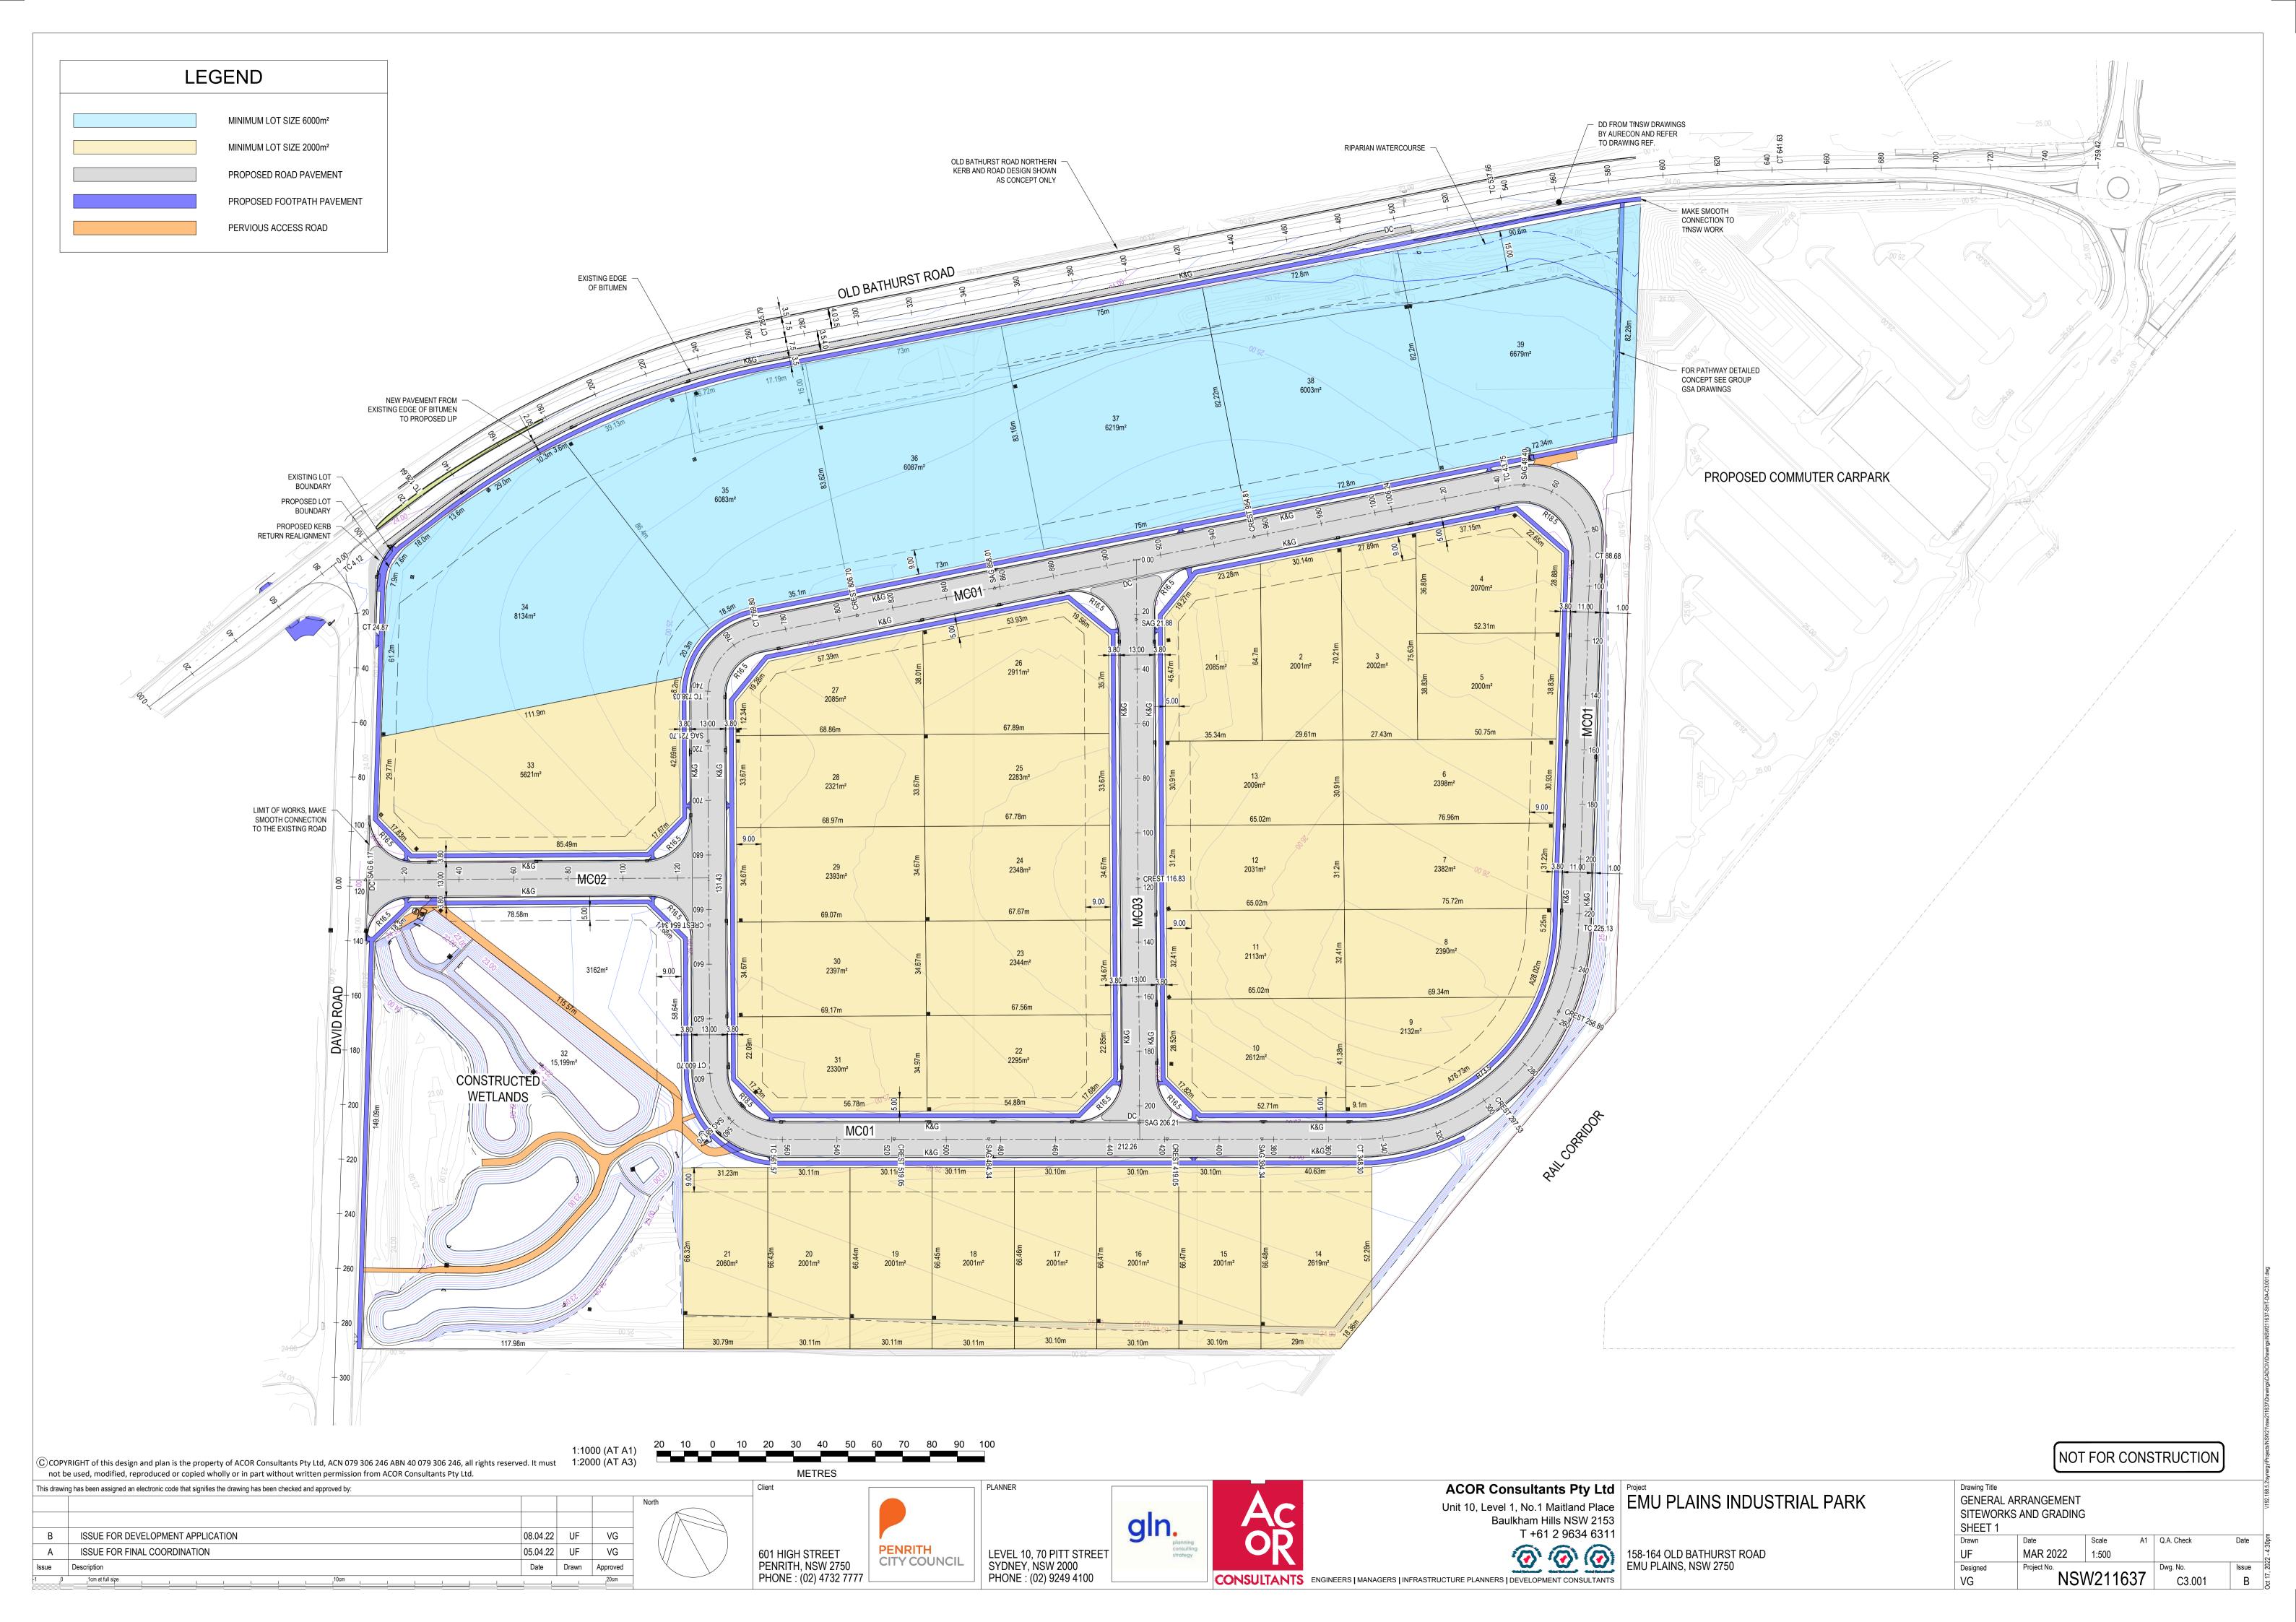
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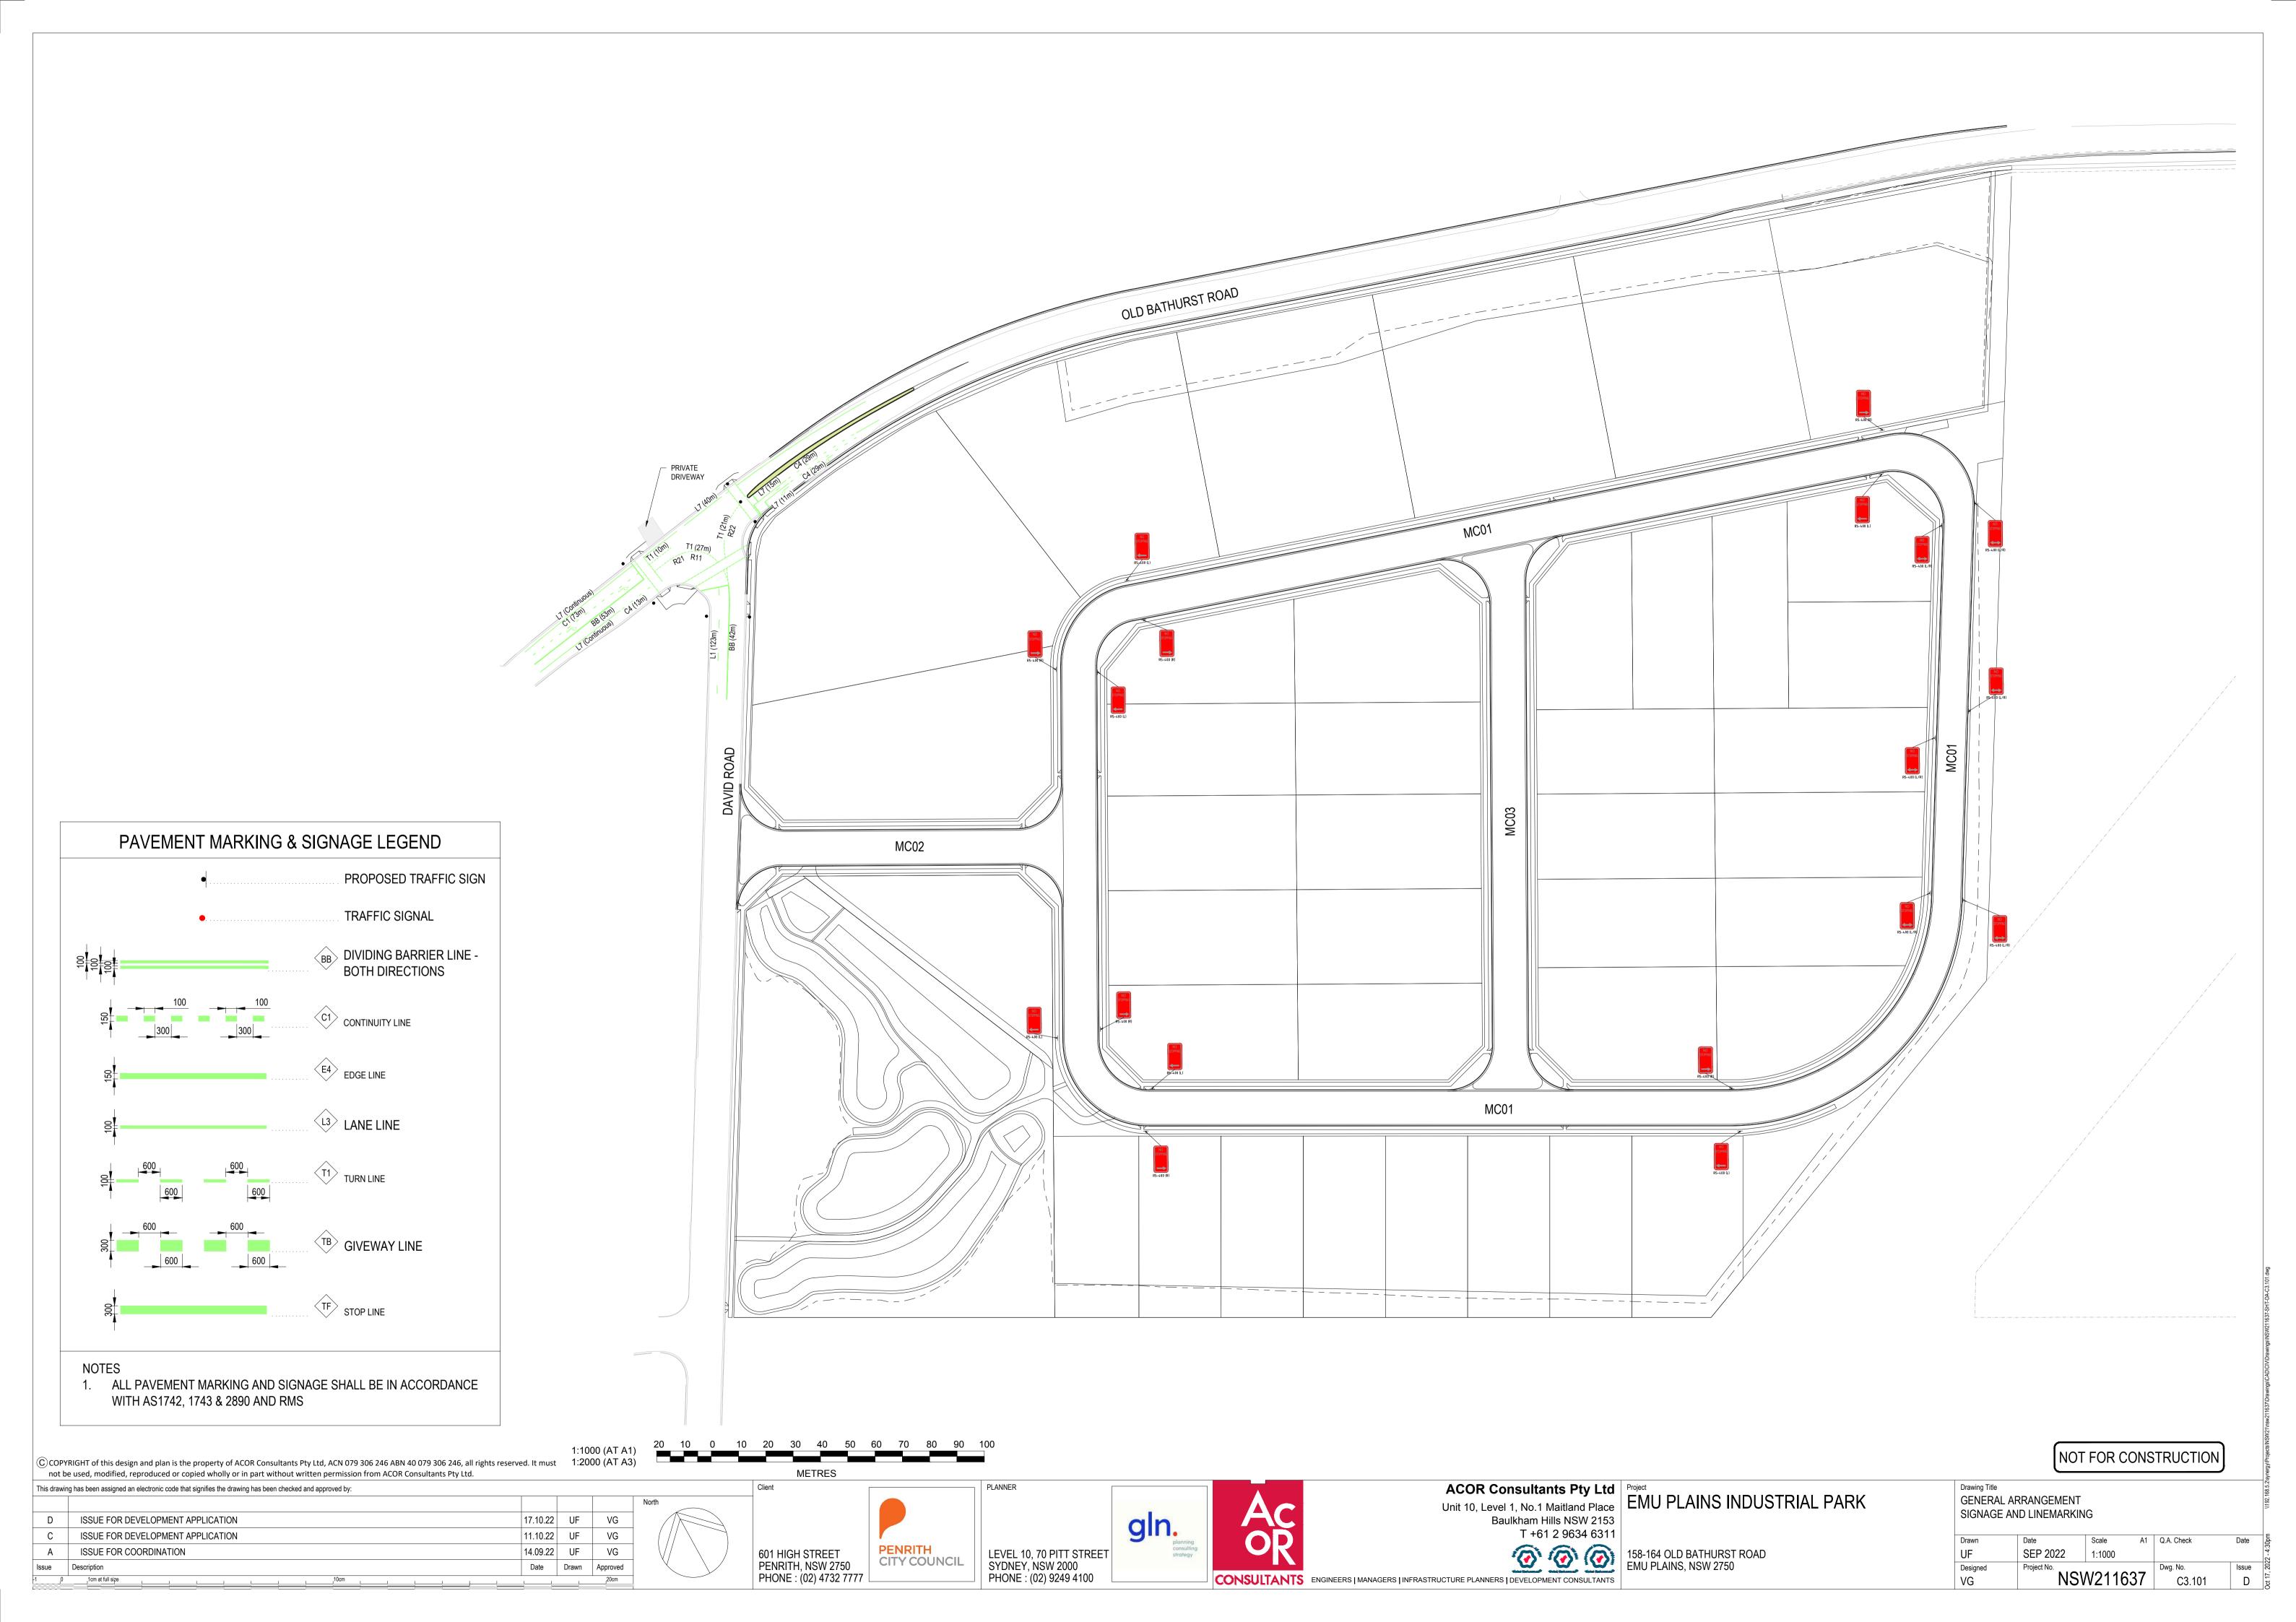




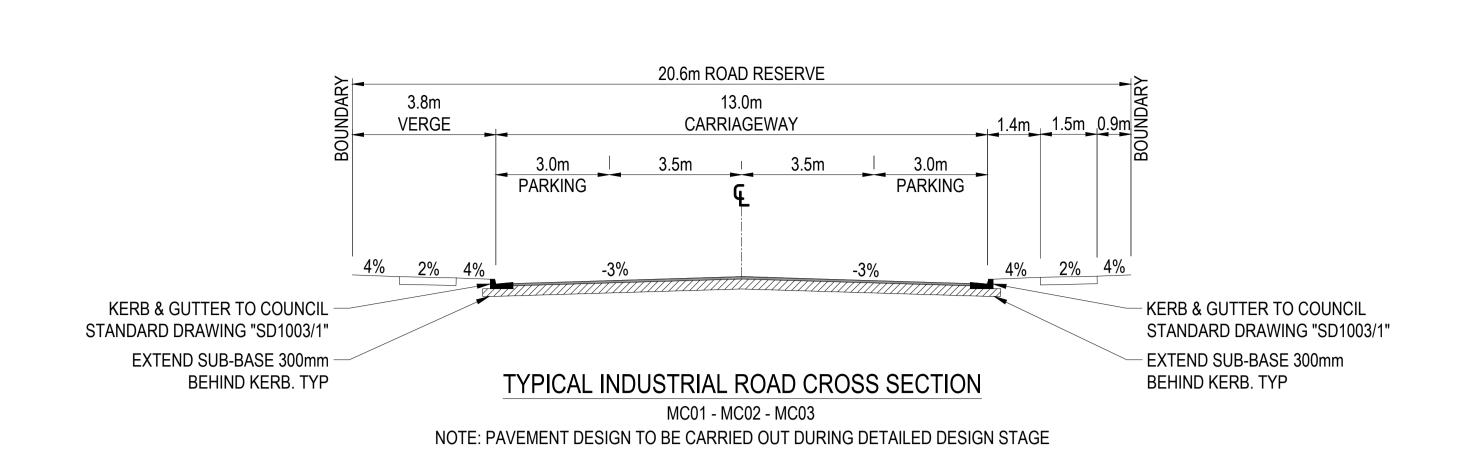
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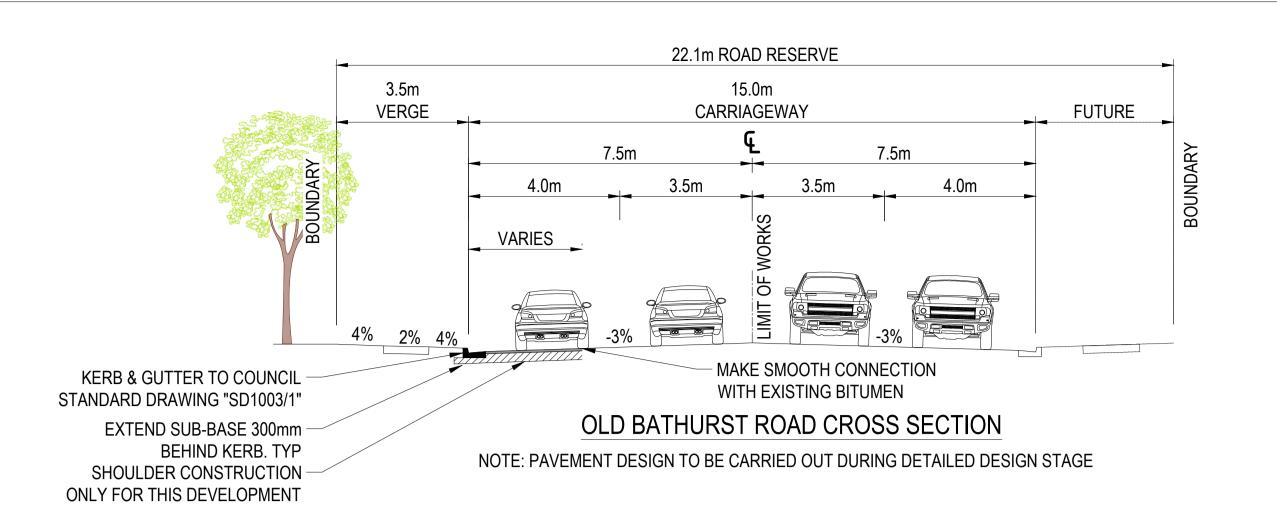
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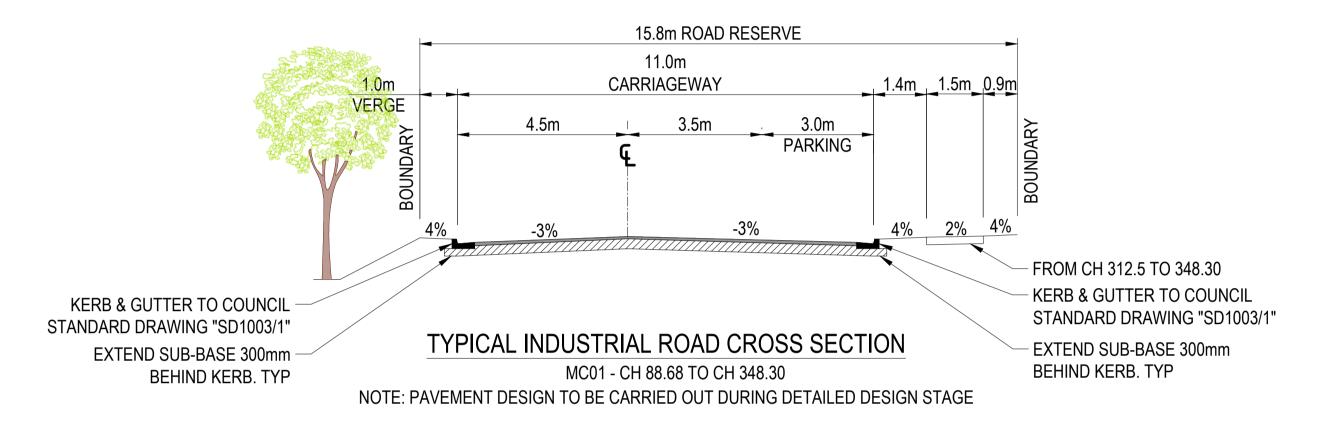


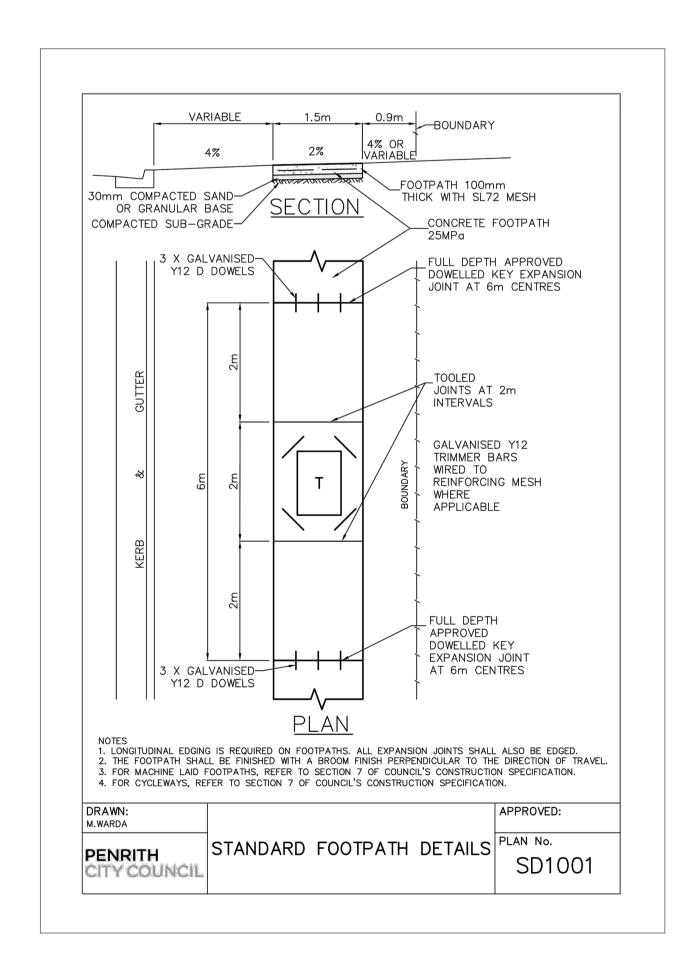


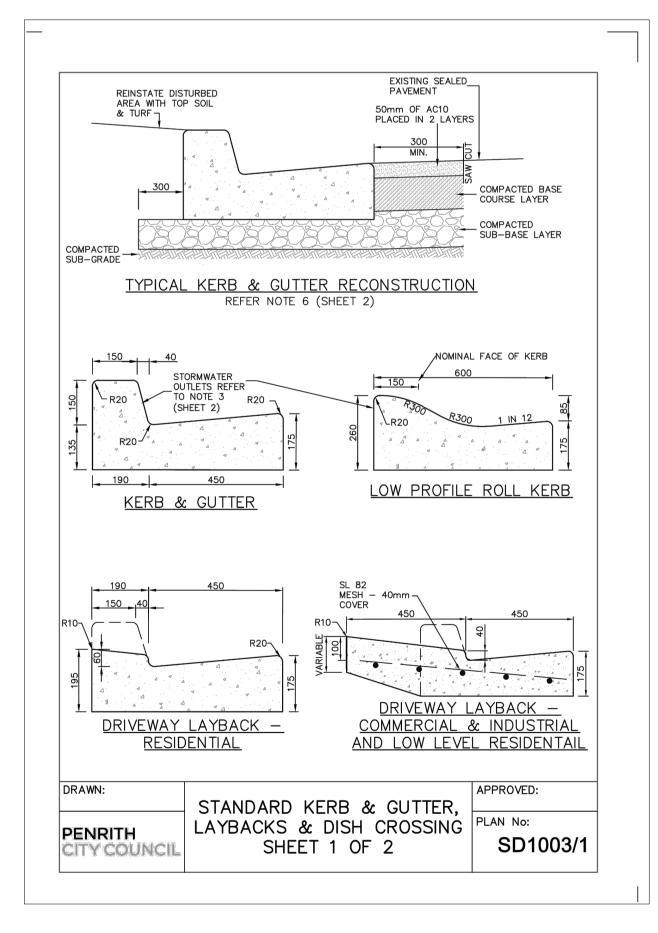


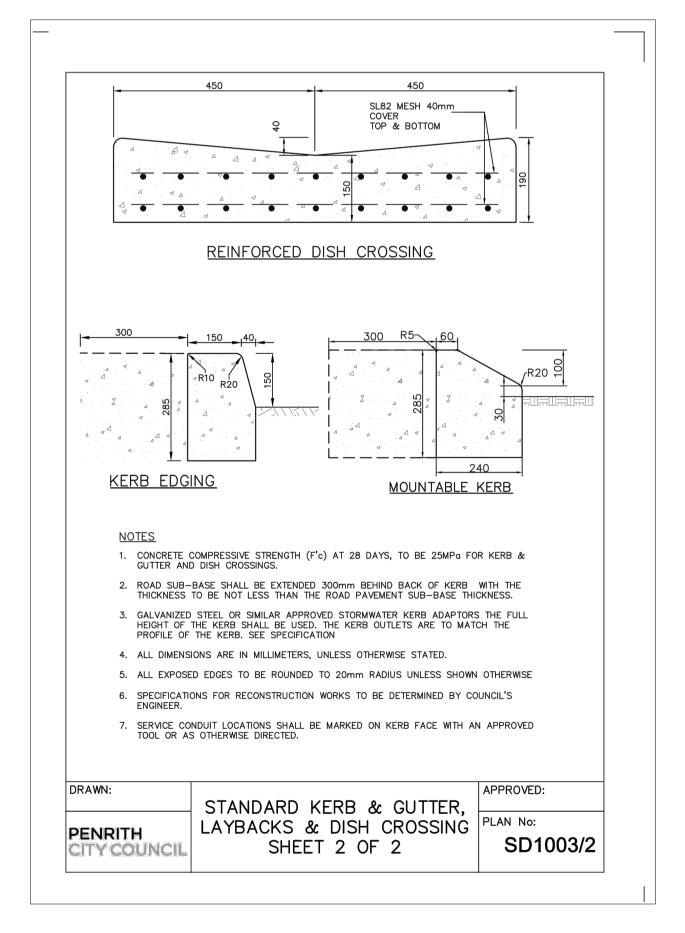


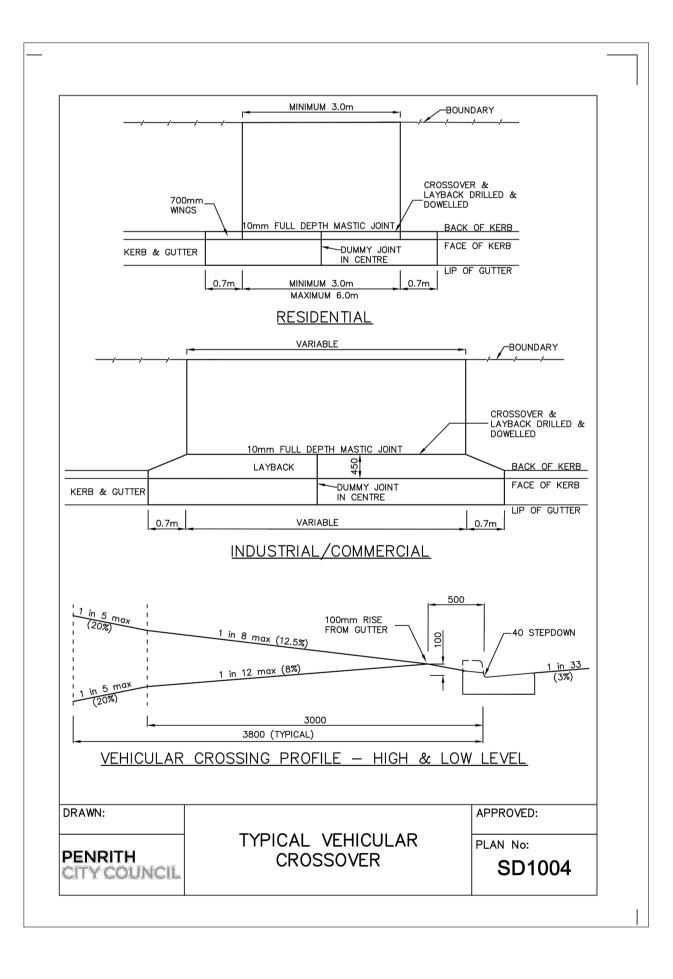













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601 HIGH STREET CITY COUNCIL PENRITH, NSW 2750 PHONE: (02) 4732 7777

PLANNER LEVEL 10, 70 PITT STREET SYDNEY, NSW 2000 PHONE: (02) 9249 4100






ACOR Consultants Pty Ltd | Project

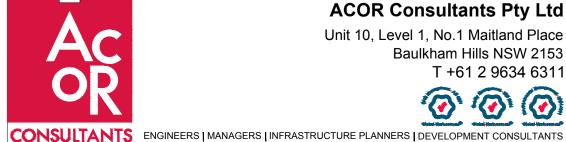
Baulkham Hills NSW 2153 T +61 2 9634 6311


Unit 10, Level 1, No.1 Maitland Place EMU PLAINS INDUSTRIAL PARK

ROAD DESIGN TYPICAL ROAD CROSS SECTION STANDARD DETAILS A1 Q.A. Check UF SEP 2022 NOT TO SCALE Designed NSW211637 C5.101

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20 10 0 10 20 30 40 50 60 70 1:1000 (AT A1) V 1:100 (AT A1) 1:2000 (AT A3) © COPYRIGHT of this design and plan is the property of ACOR Consultants Pty Ltd, ACN 079 306 246 ABN 40 079 306 246, all rights reserved. It must **METRES METRES** not be used, modified, reproduced or copied wholly or in part without written permission from ACOR Consultants Pty Ltd. Client PLANNER
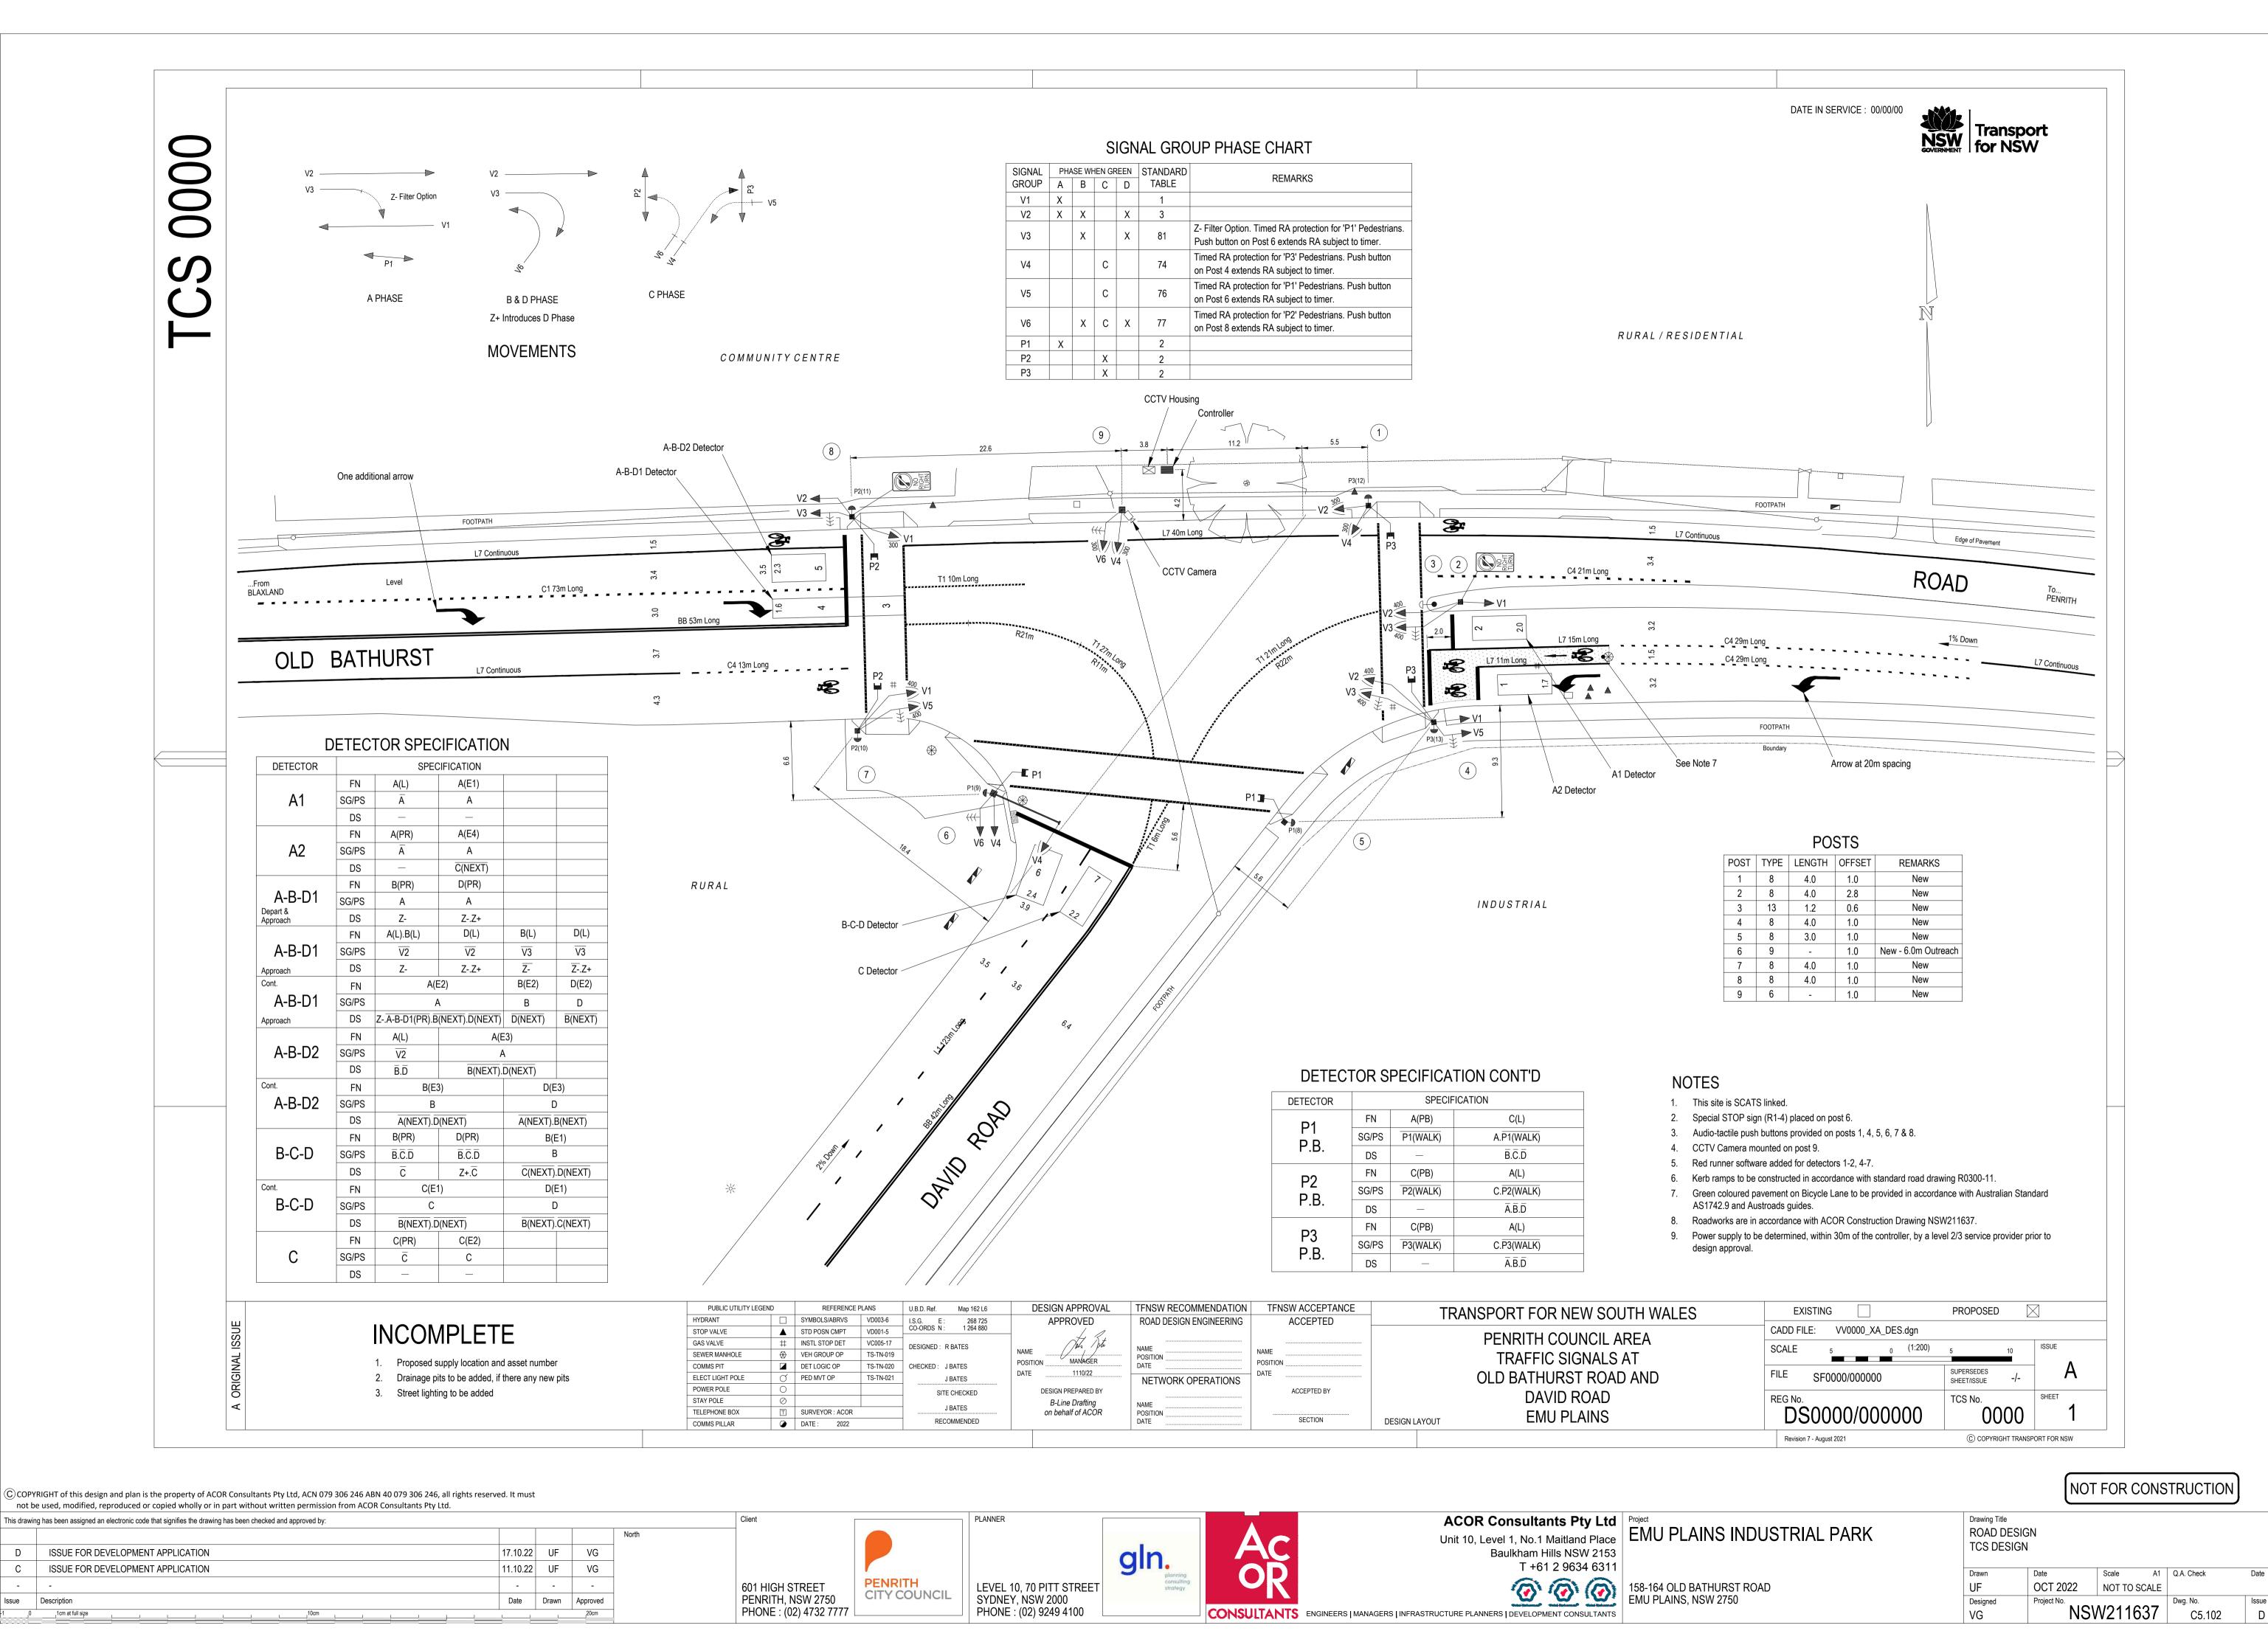
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ACOR Consultants Pty Ltd
Unit 10, Level 1, No.1 Maitland Place

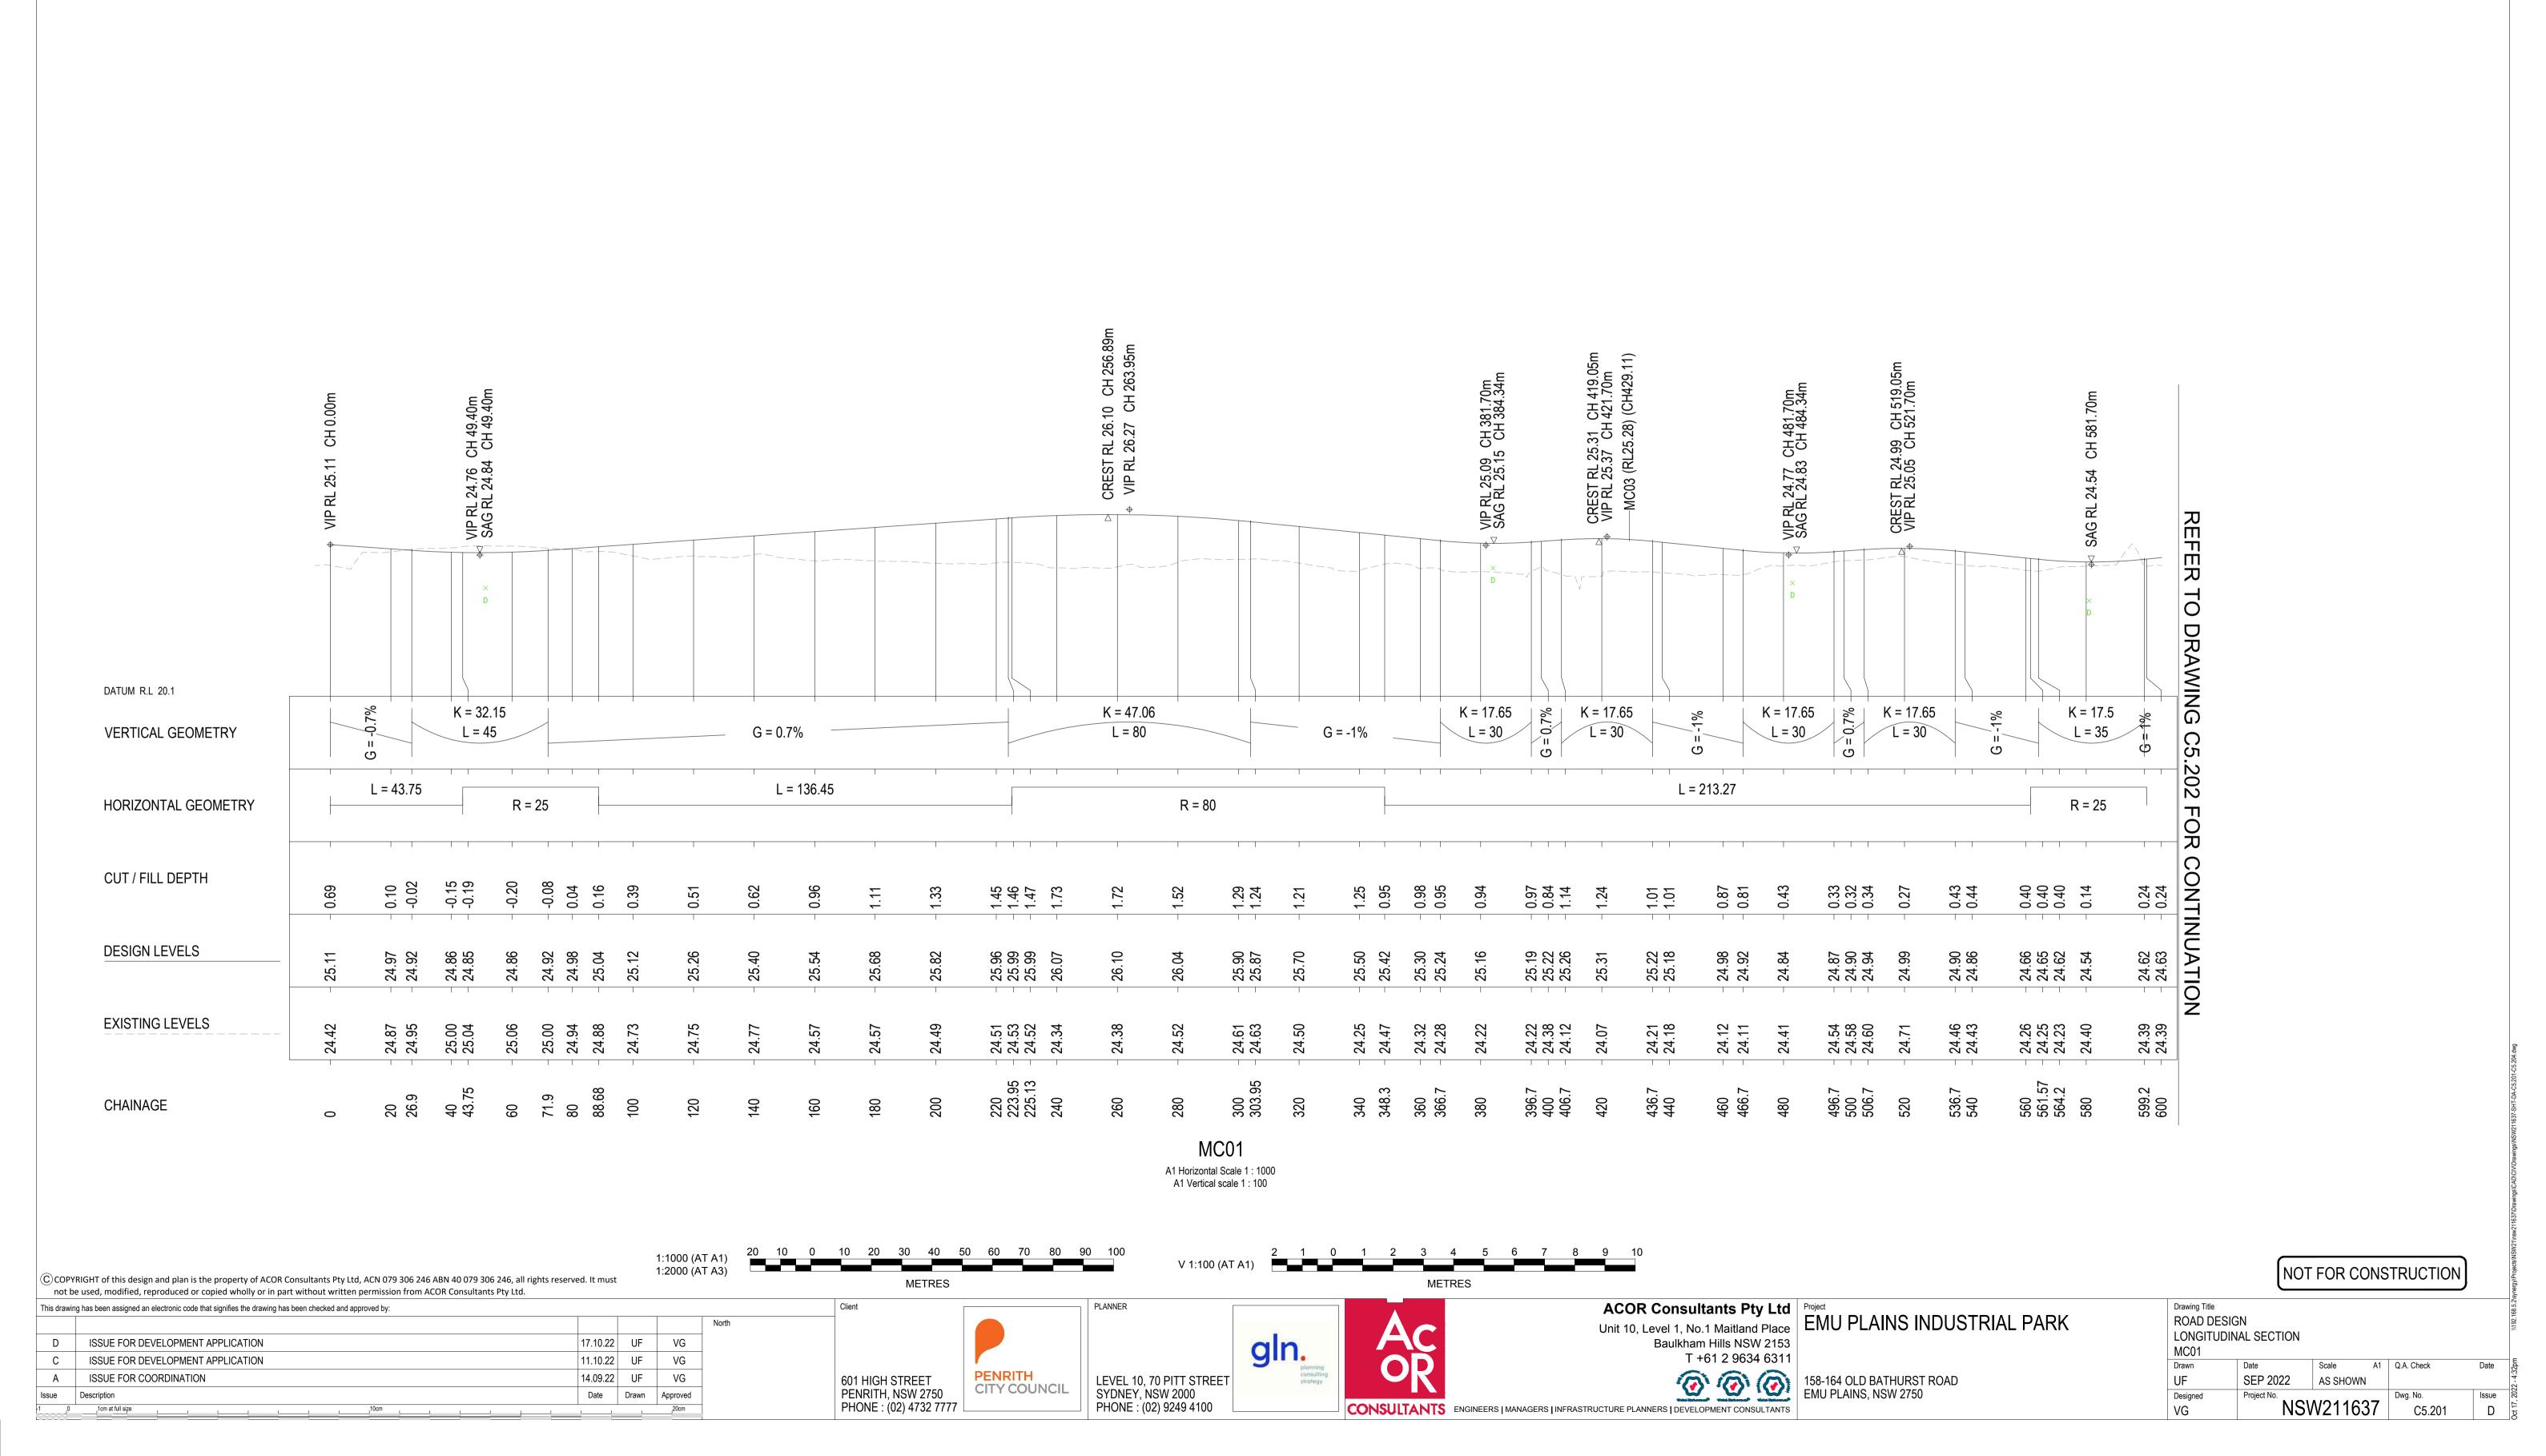Project
EMU PLAINS INDUSTRIAL PARK

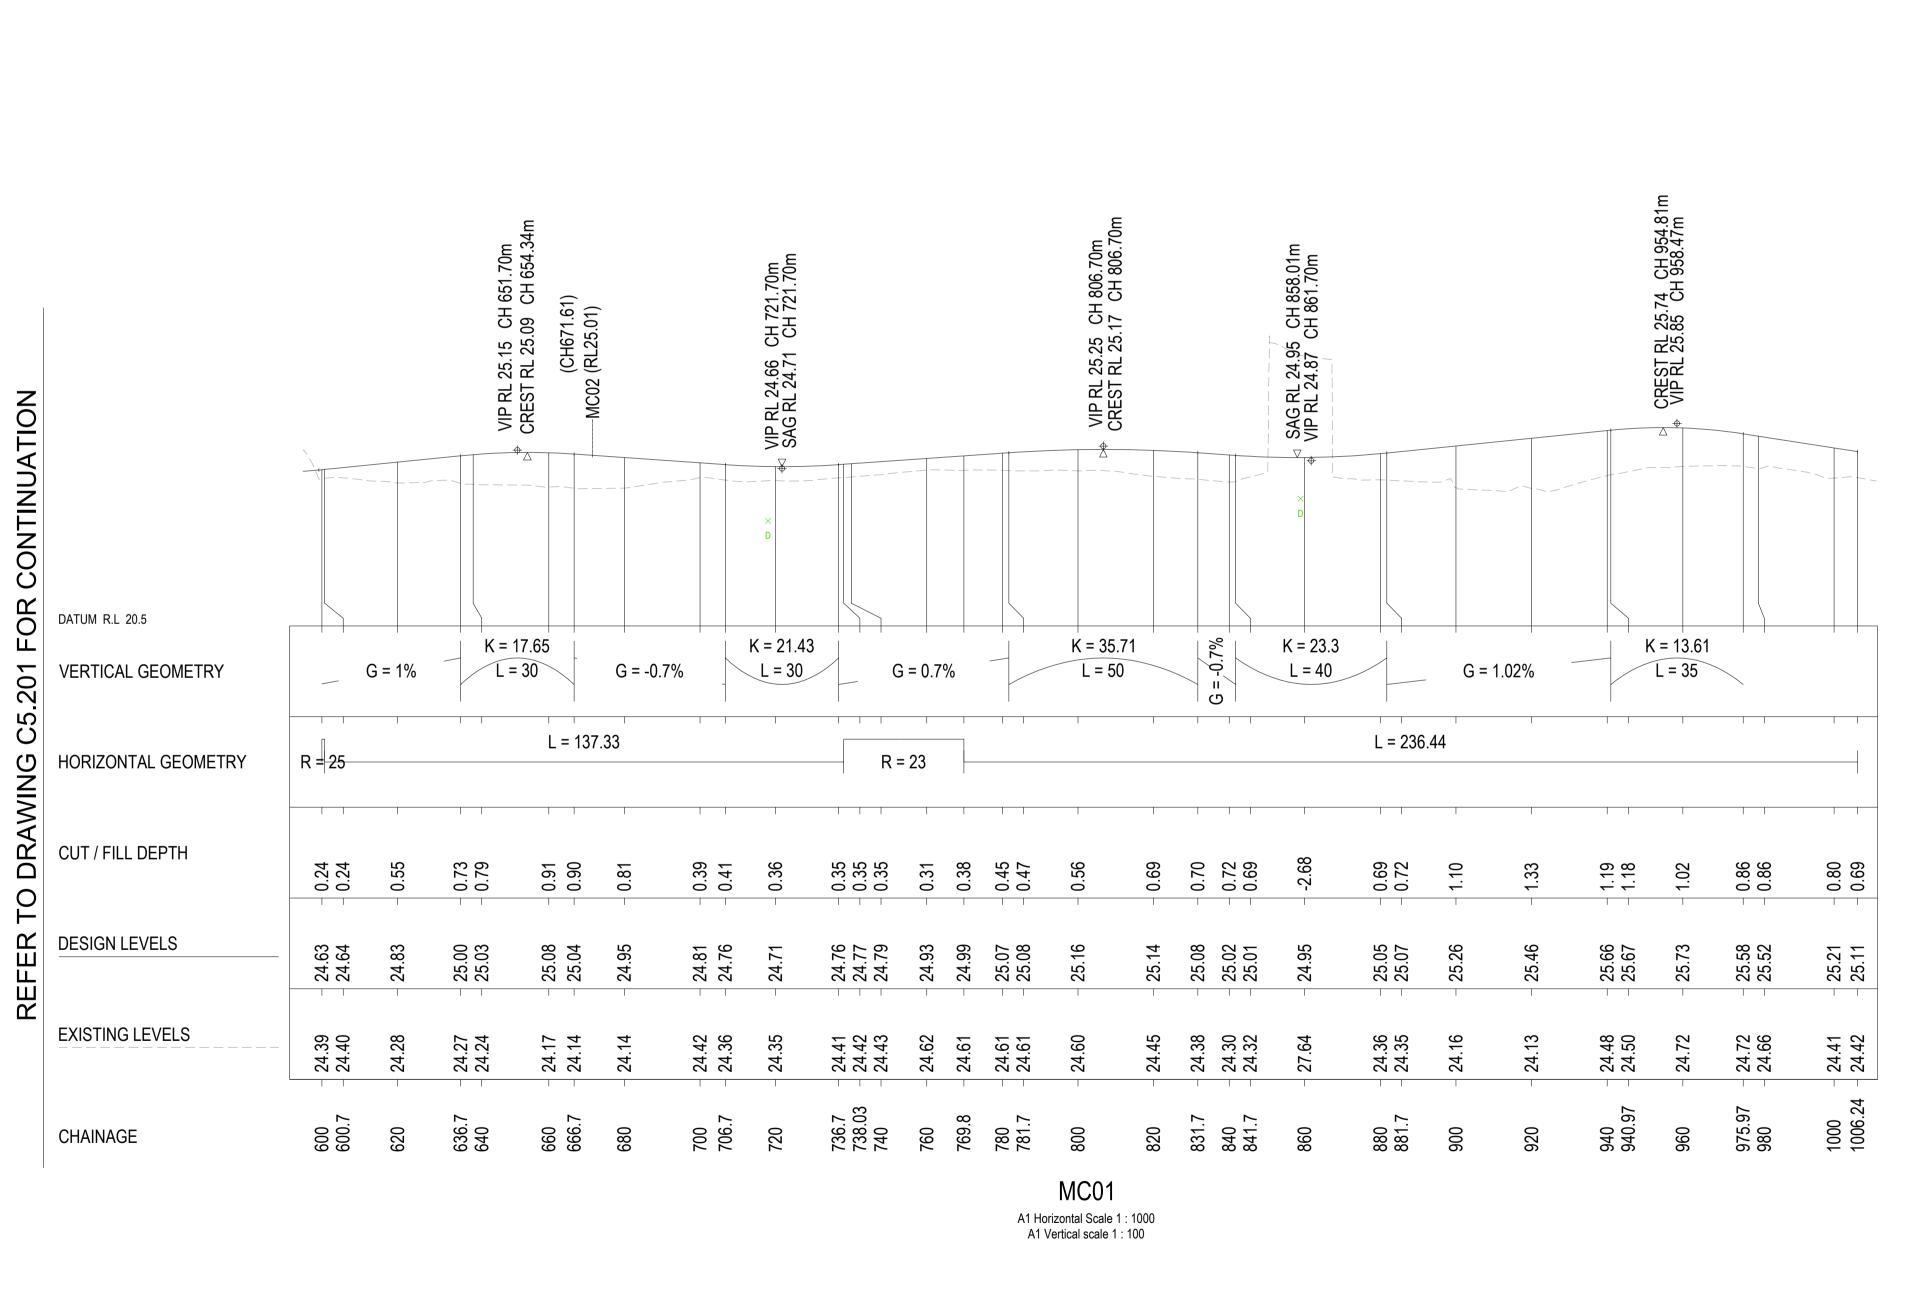Drawing Title ROAD DESIGN LONGITUDINAL SECTION MC01 Drawn A1 Q.A. Check Scale UF SEP 2022 AS SHOWN Designed NSW211637 VG C5.202 D |

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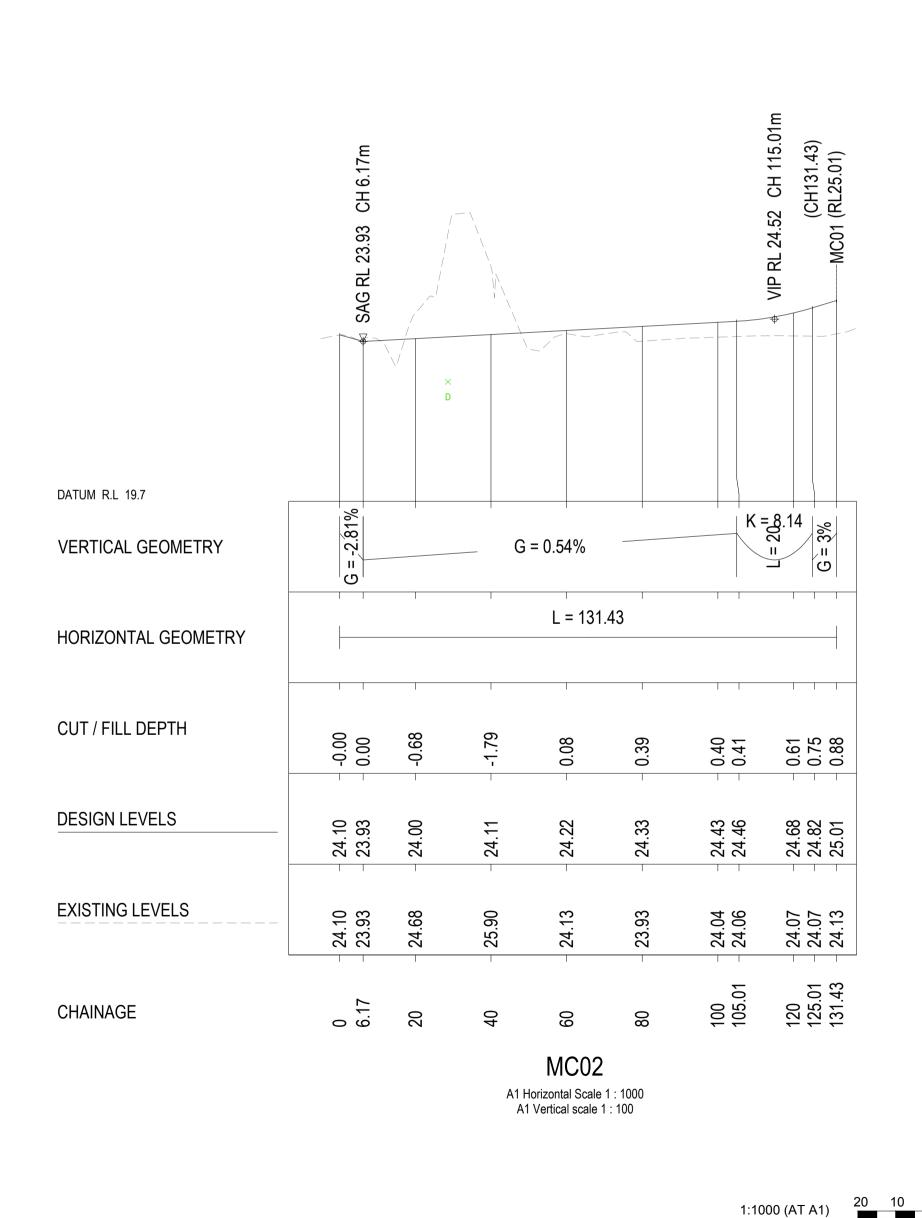
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D	ISSUE FOR DEVELOPMENT APPLICATION	17.10.22	UF	VG	
С	ISSUE FOR DEVELOPMENT APPLICATION	11.10.22	UF	VG	
Α	ISSUE FOR COORDINATION	14.09.22	UF	VG	
			_		

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ISSUE FOR DEVELOPMENT APPLICATION

1:2000 (AT A3)

VG

VG

VG

17.10.22 UF

11.10.22 UF

14.09.22 UF

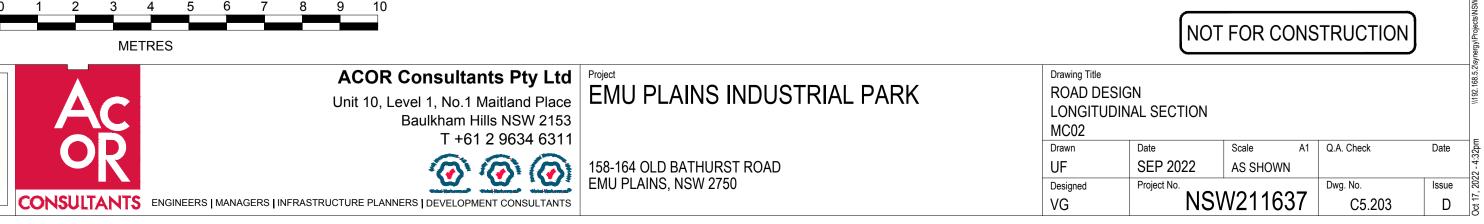
Date Drawn Approved

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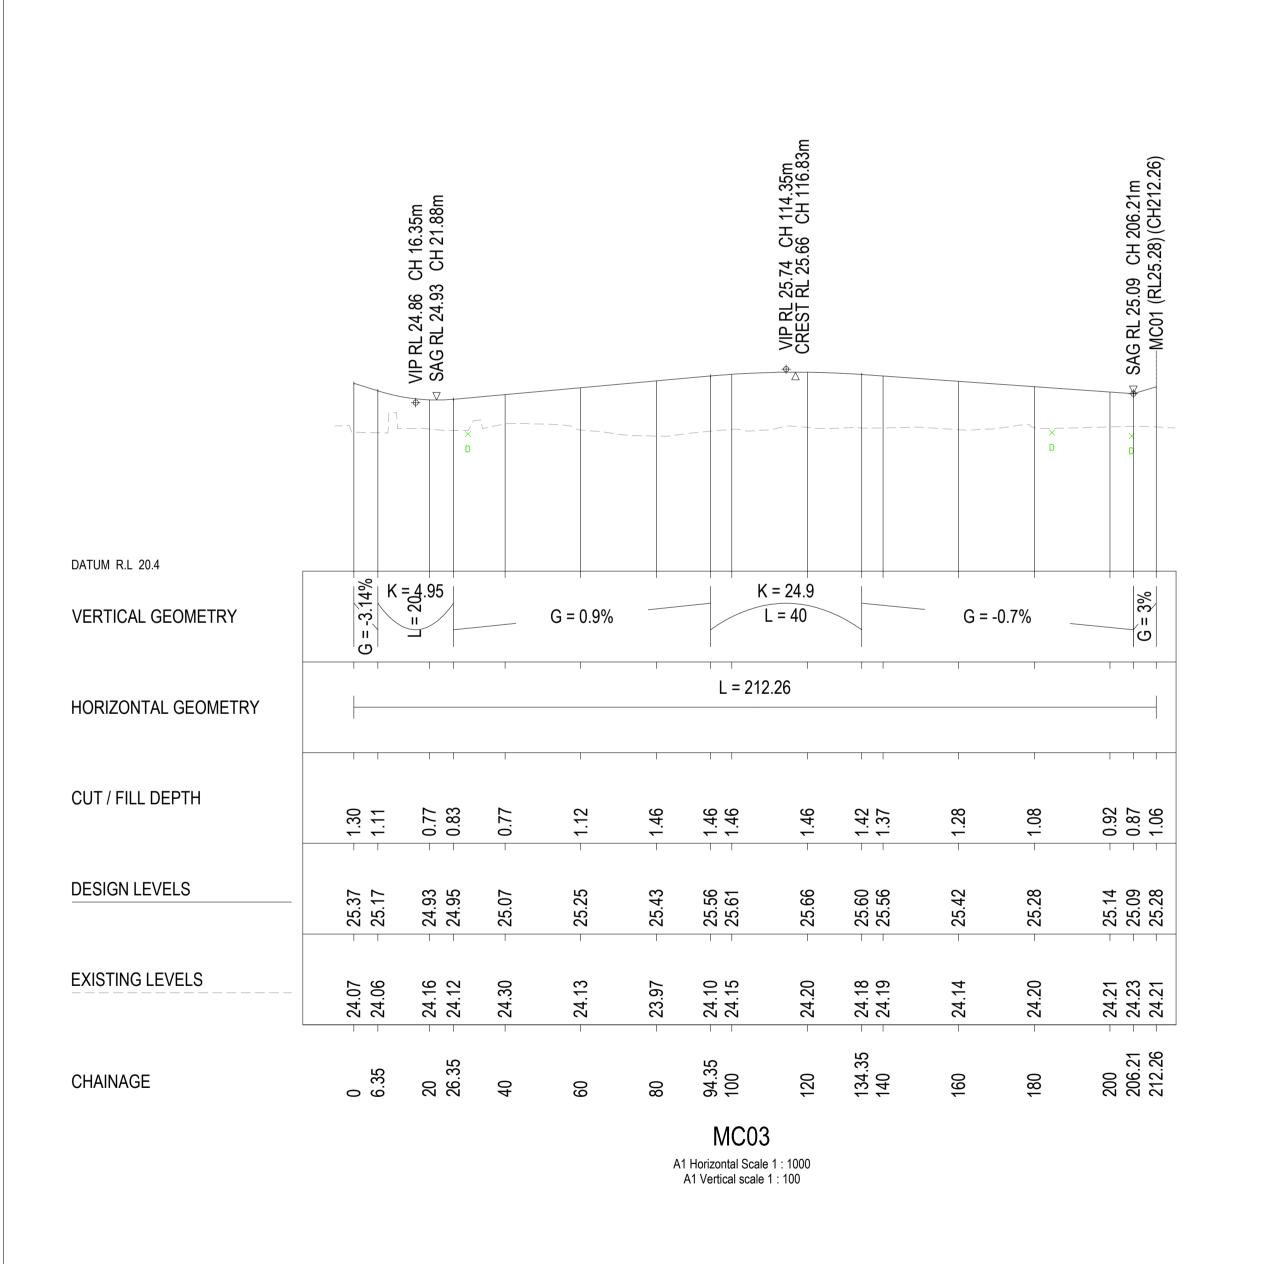
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V 1:100 (AT A1)

PLANNER

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ISSUE FOR DEVELOPMENT APPLICATION

1:1000 (AT A1)

1:2000 (AT A3)

VG

VG

VG

17.10.22 UF

11.10.22 UF

14.09.22 UF

Date Drawn Approved

METRES

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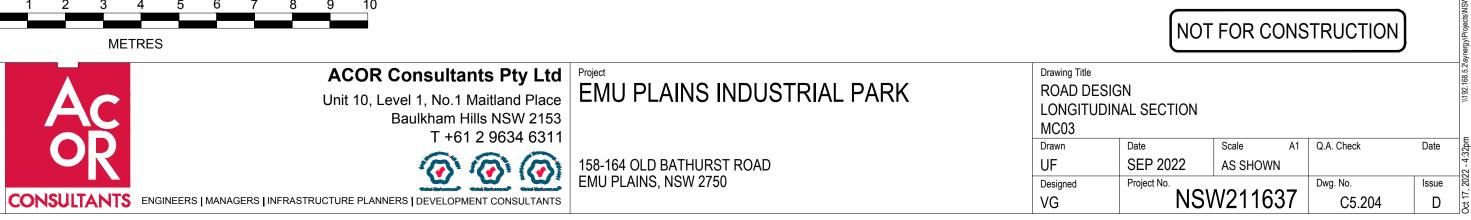
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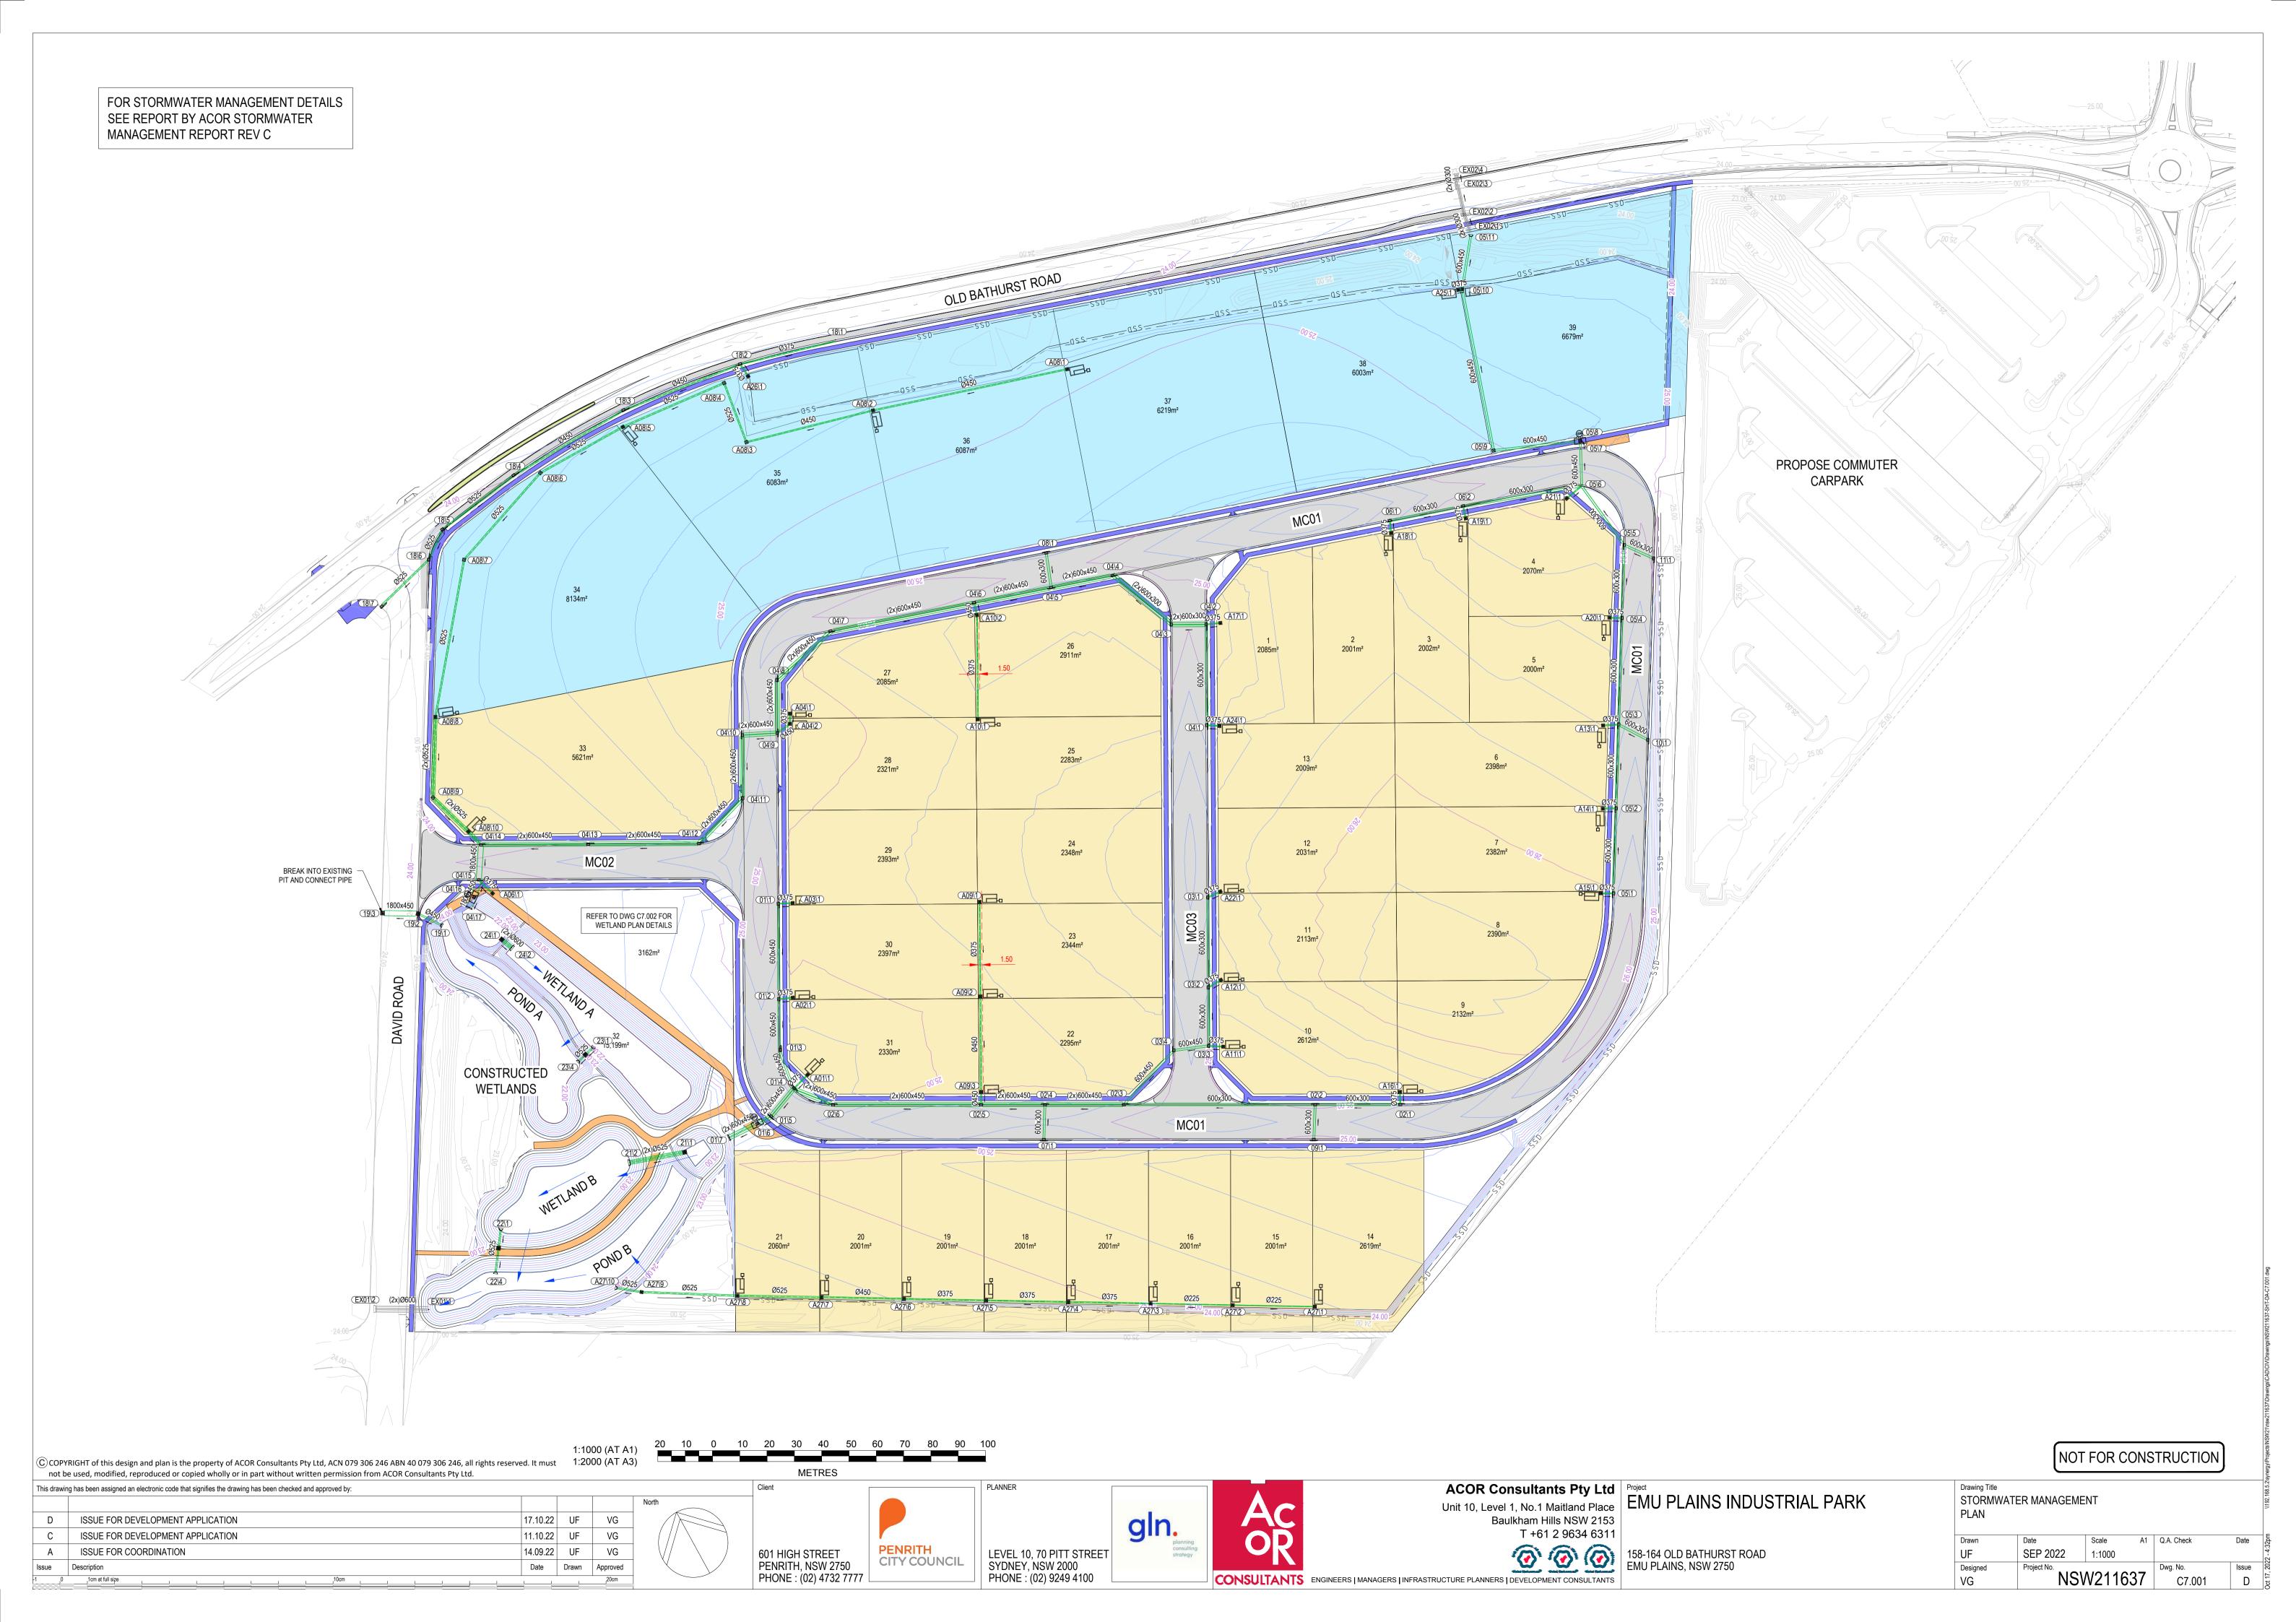
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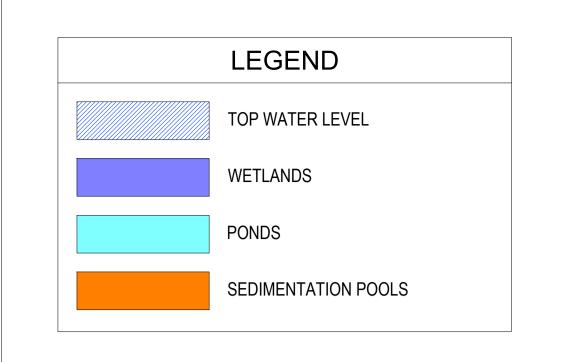
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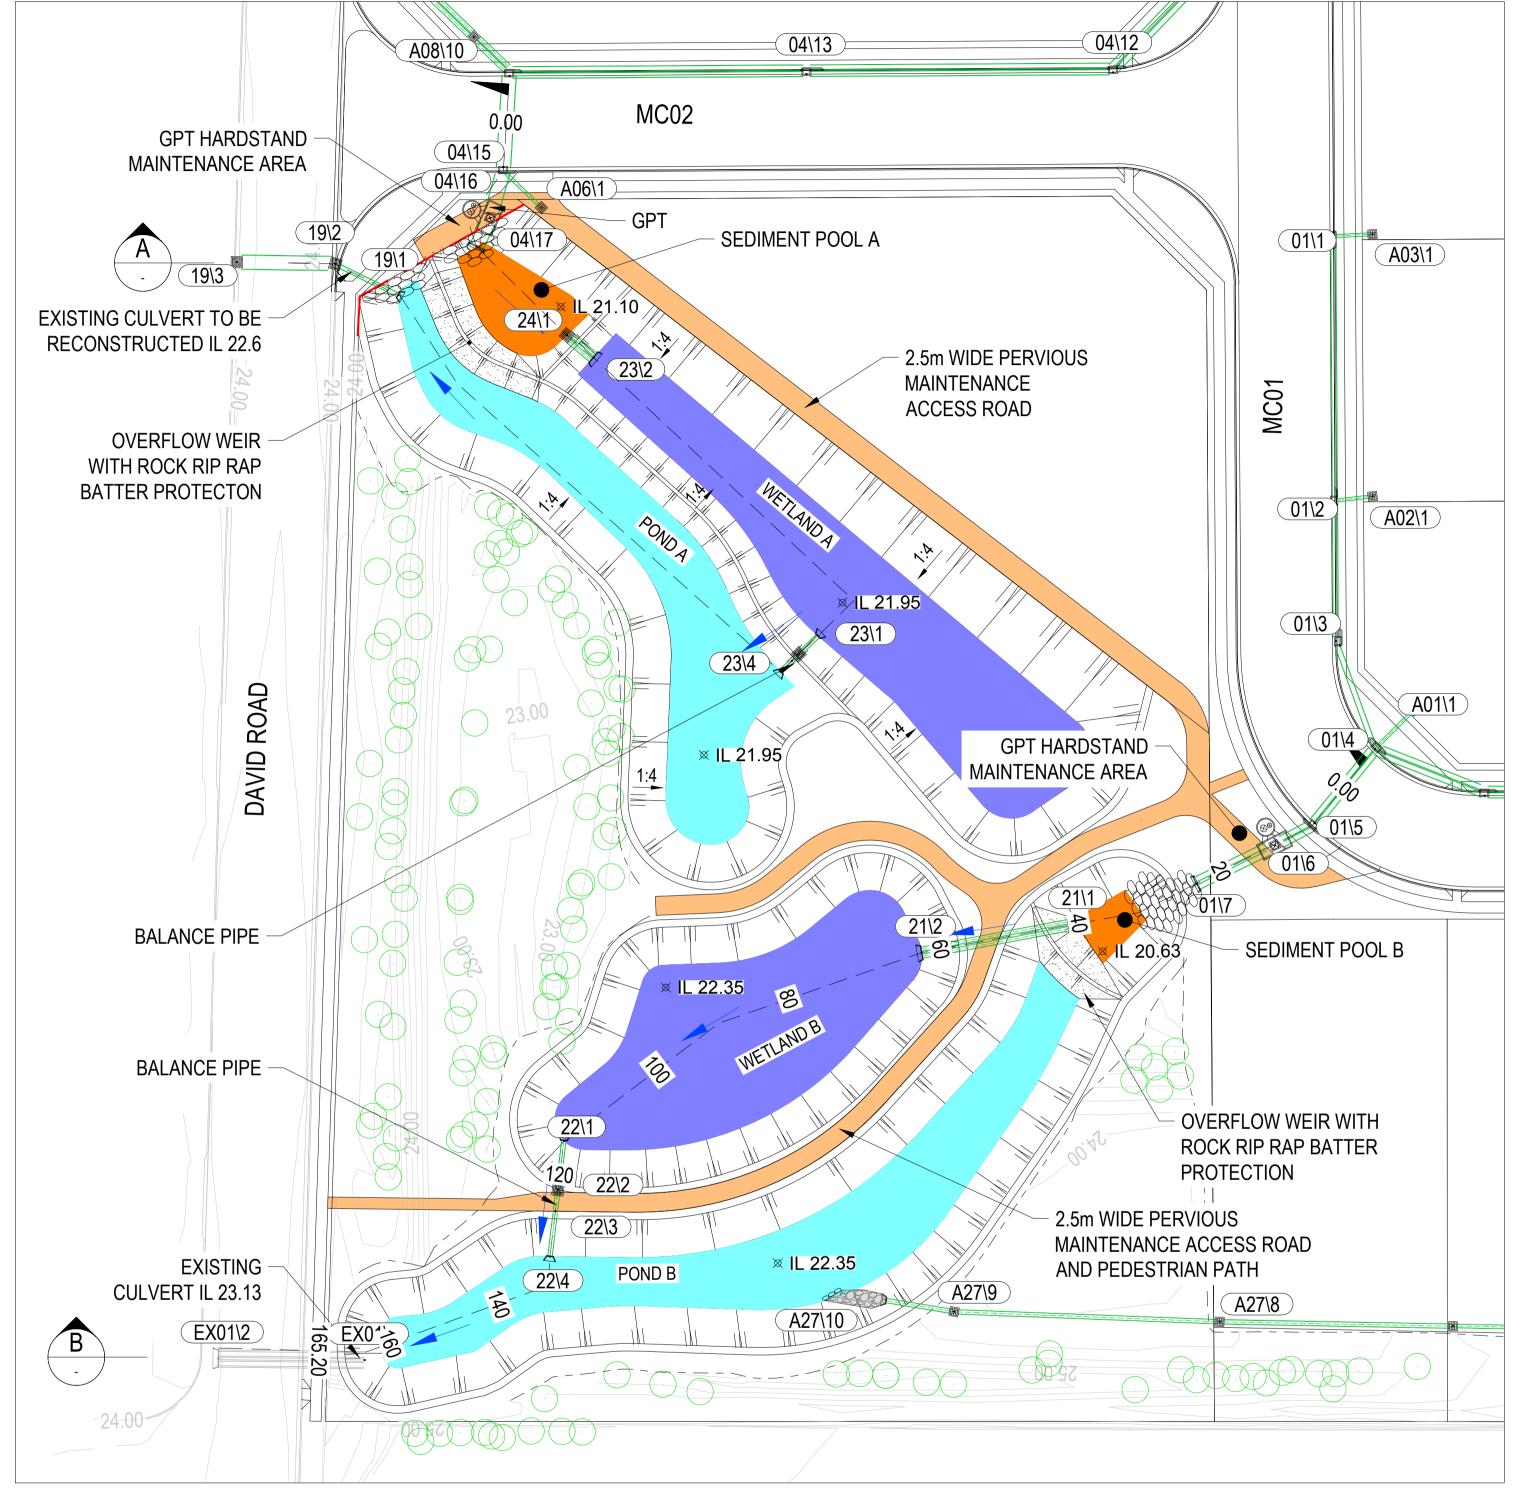
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METRES












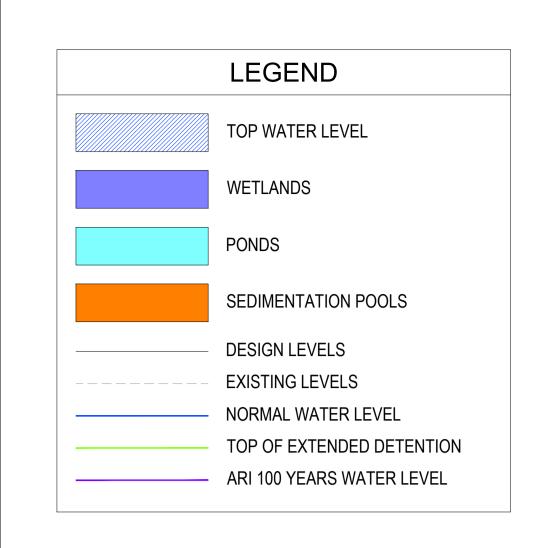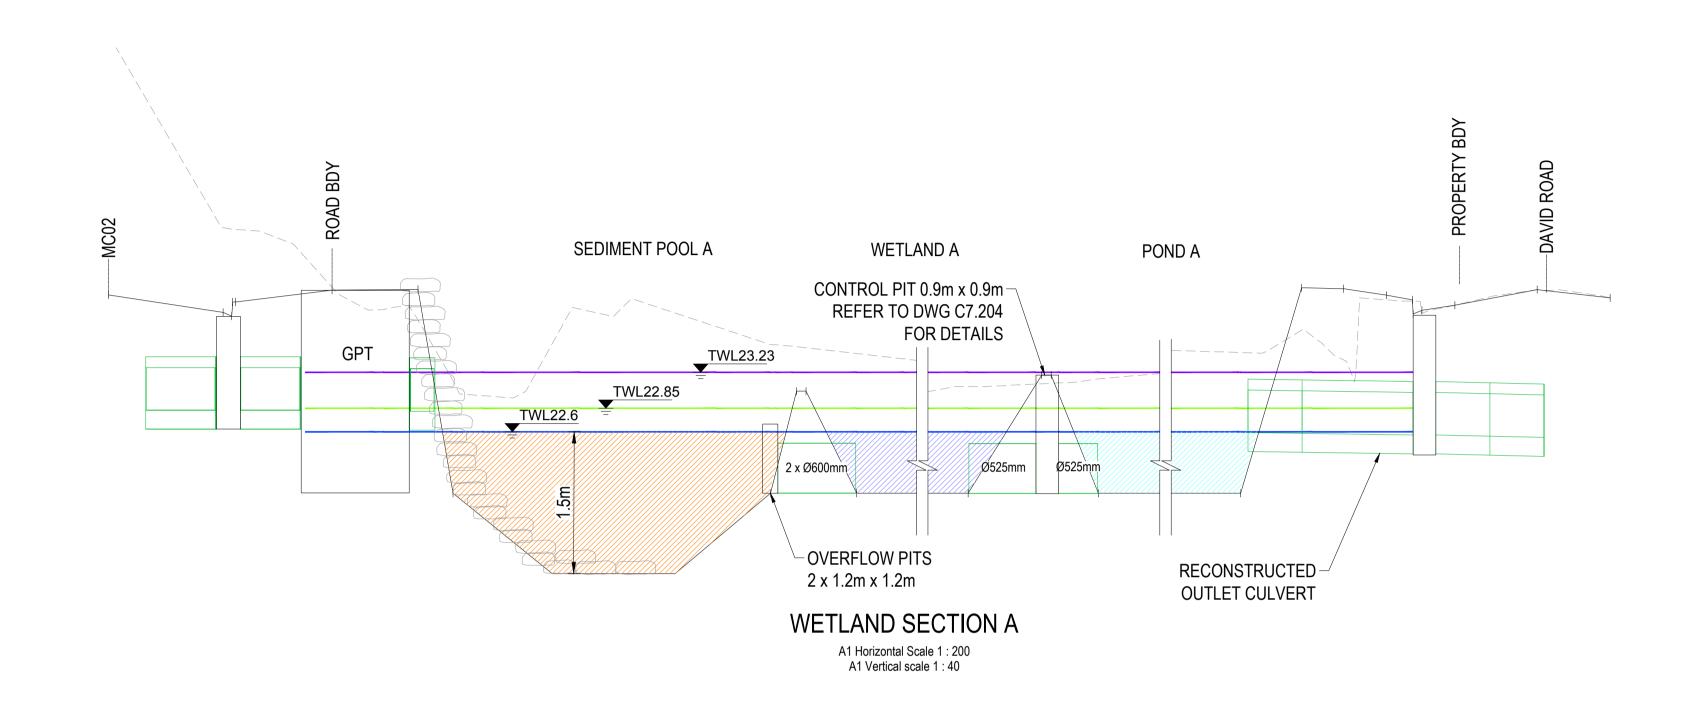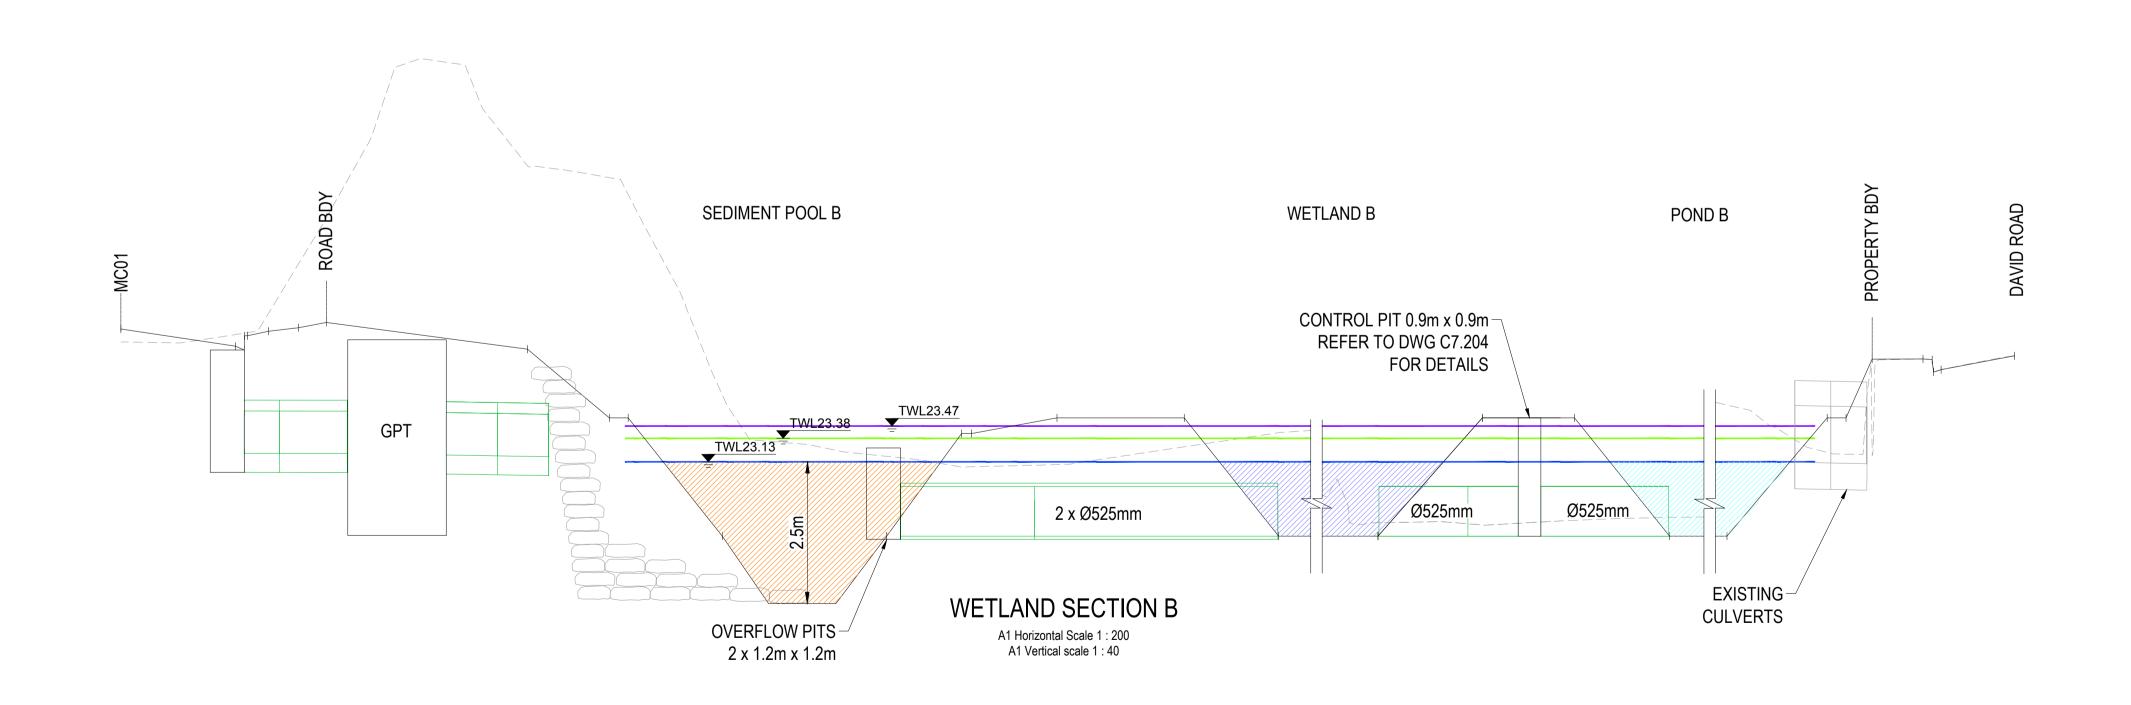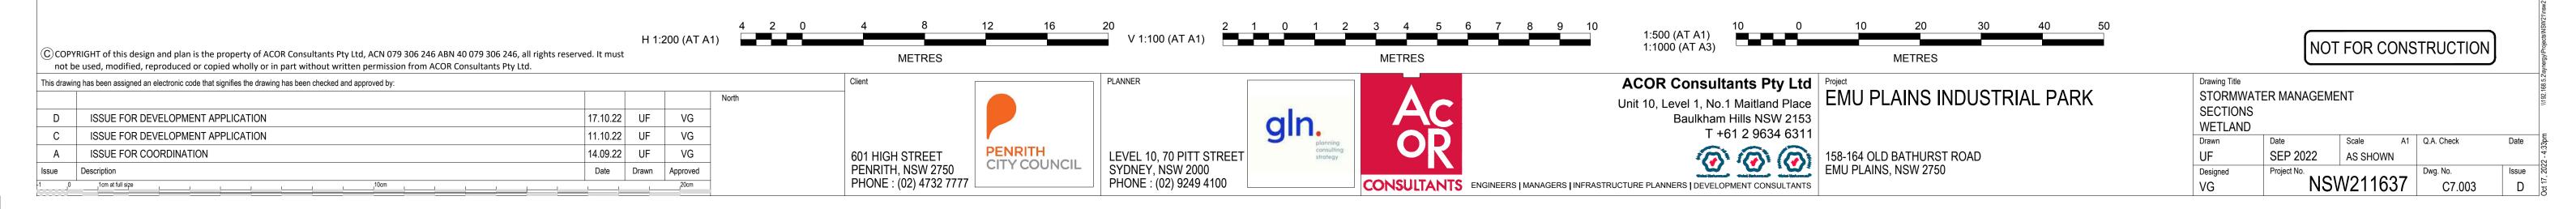
PLAN OF CONSTRUCTED WETLANDS
SCALE 1:500

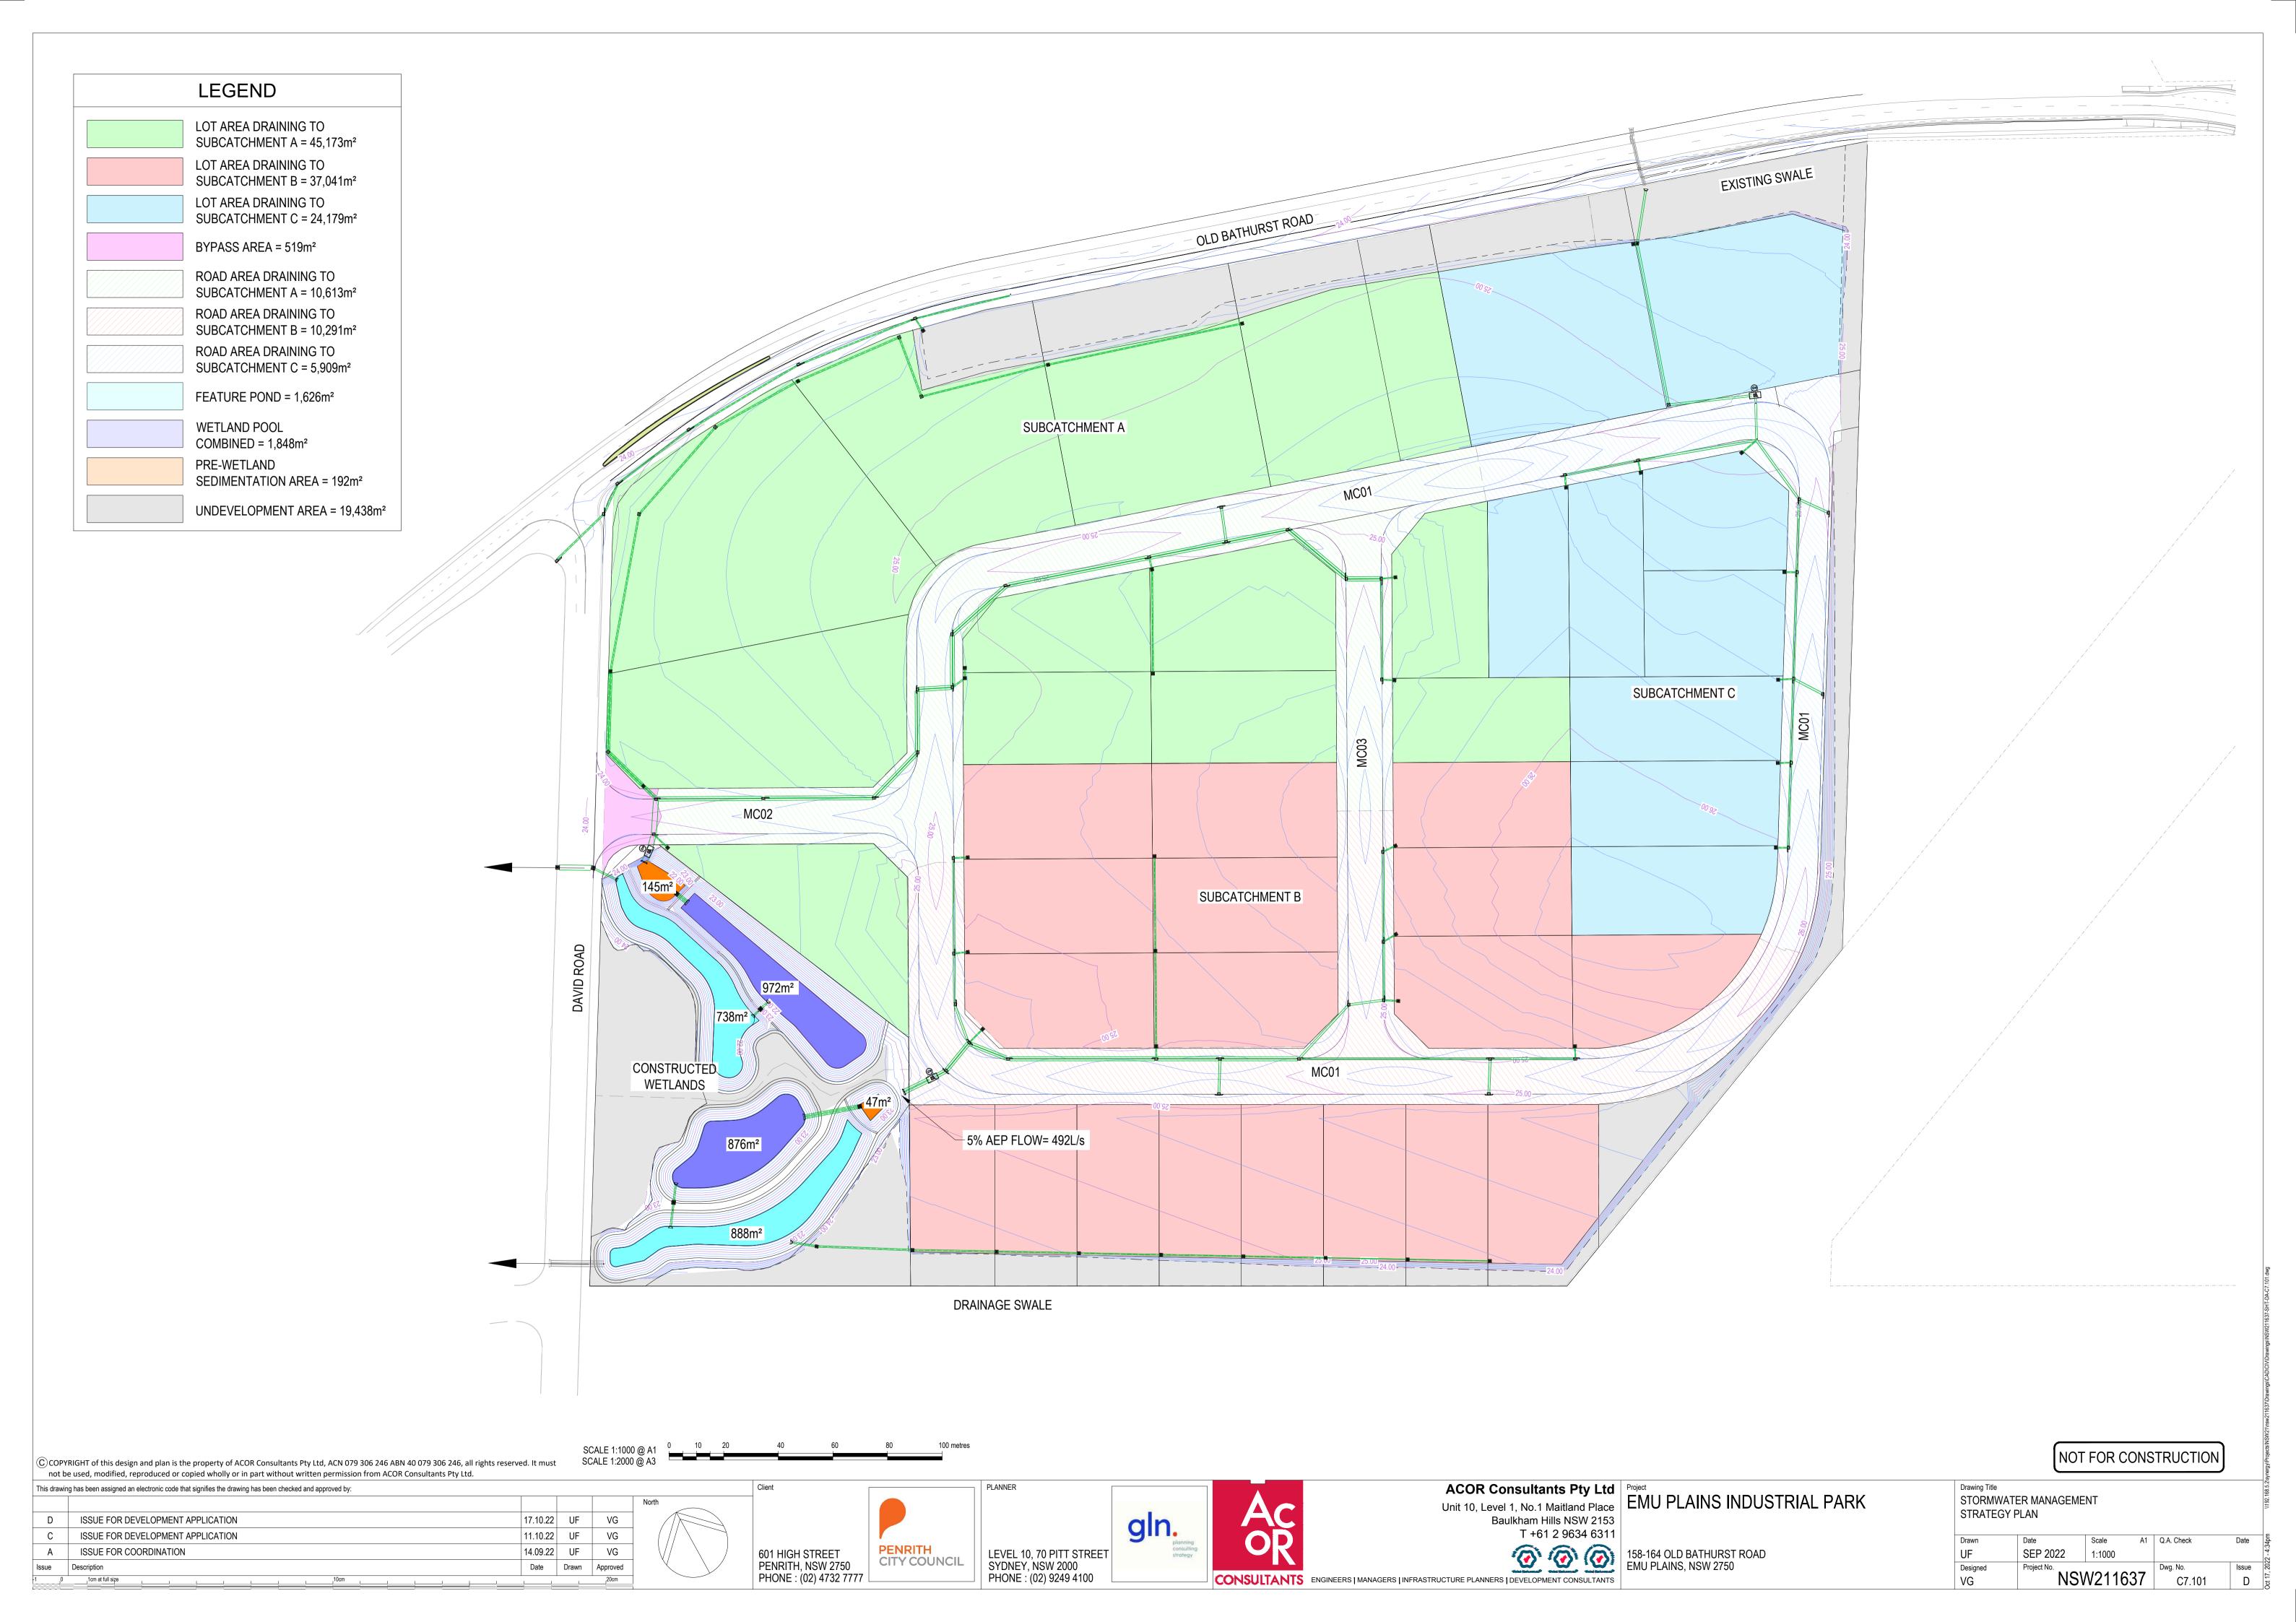


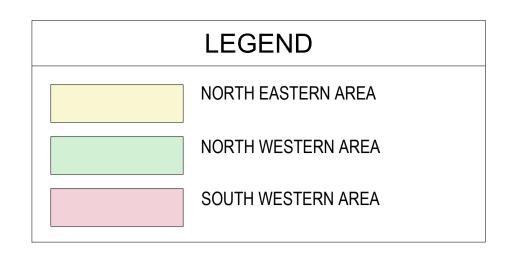






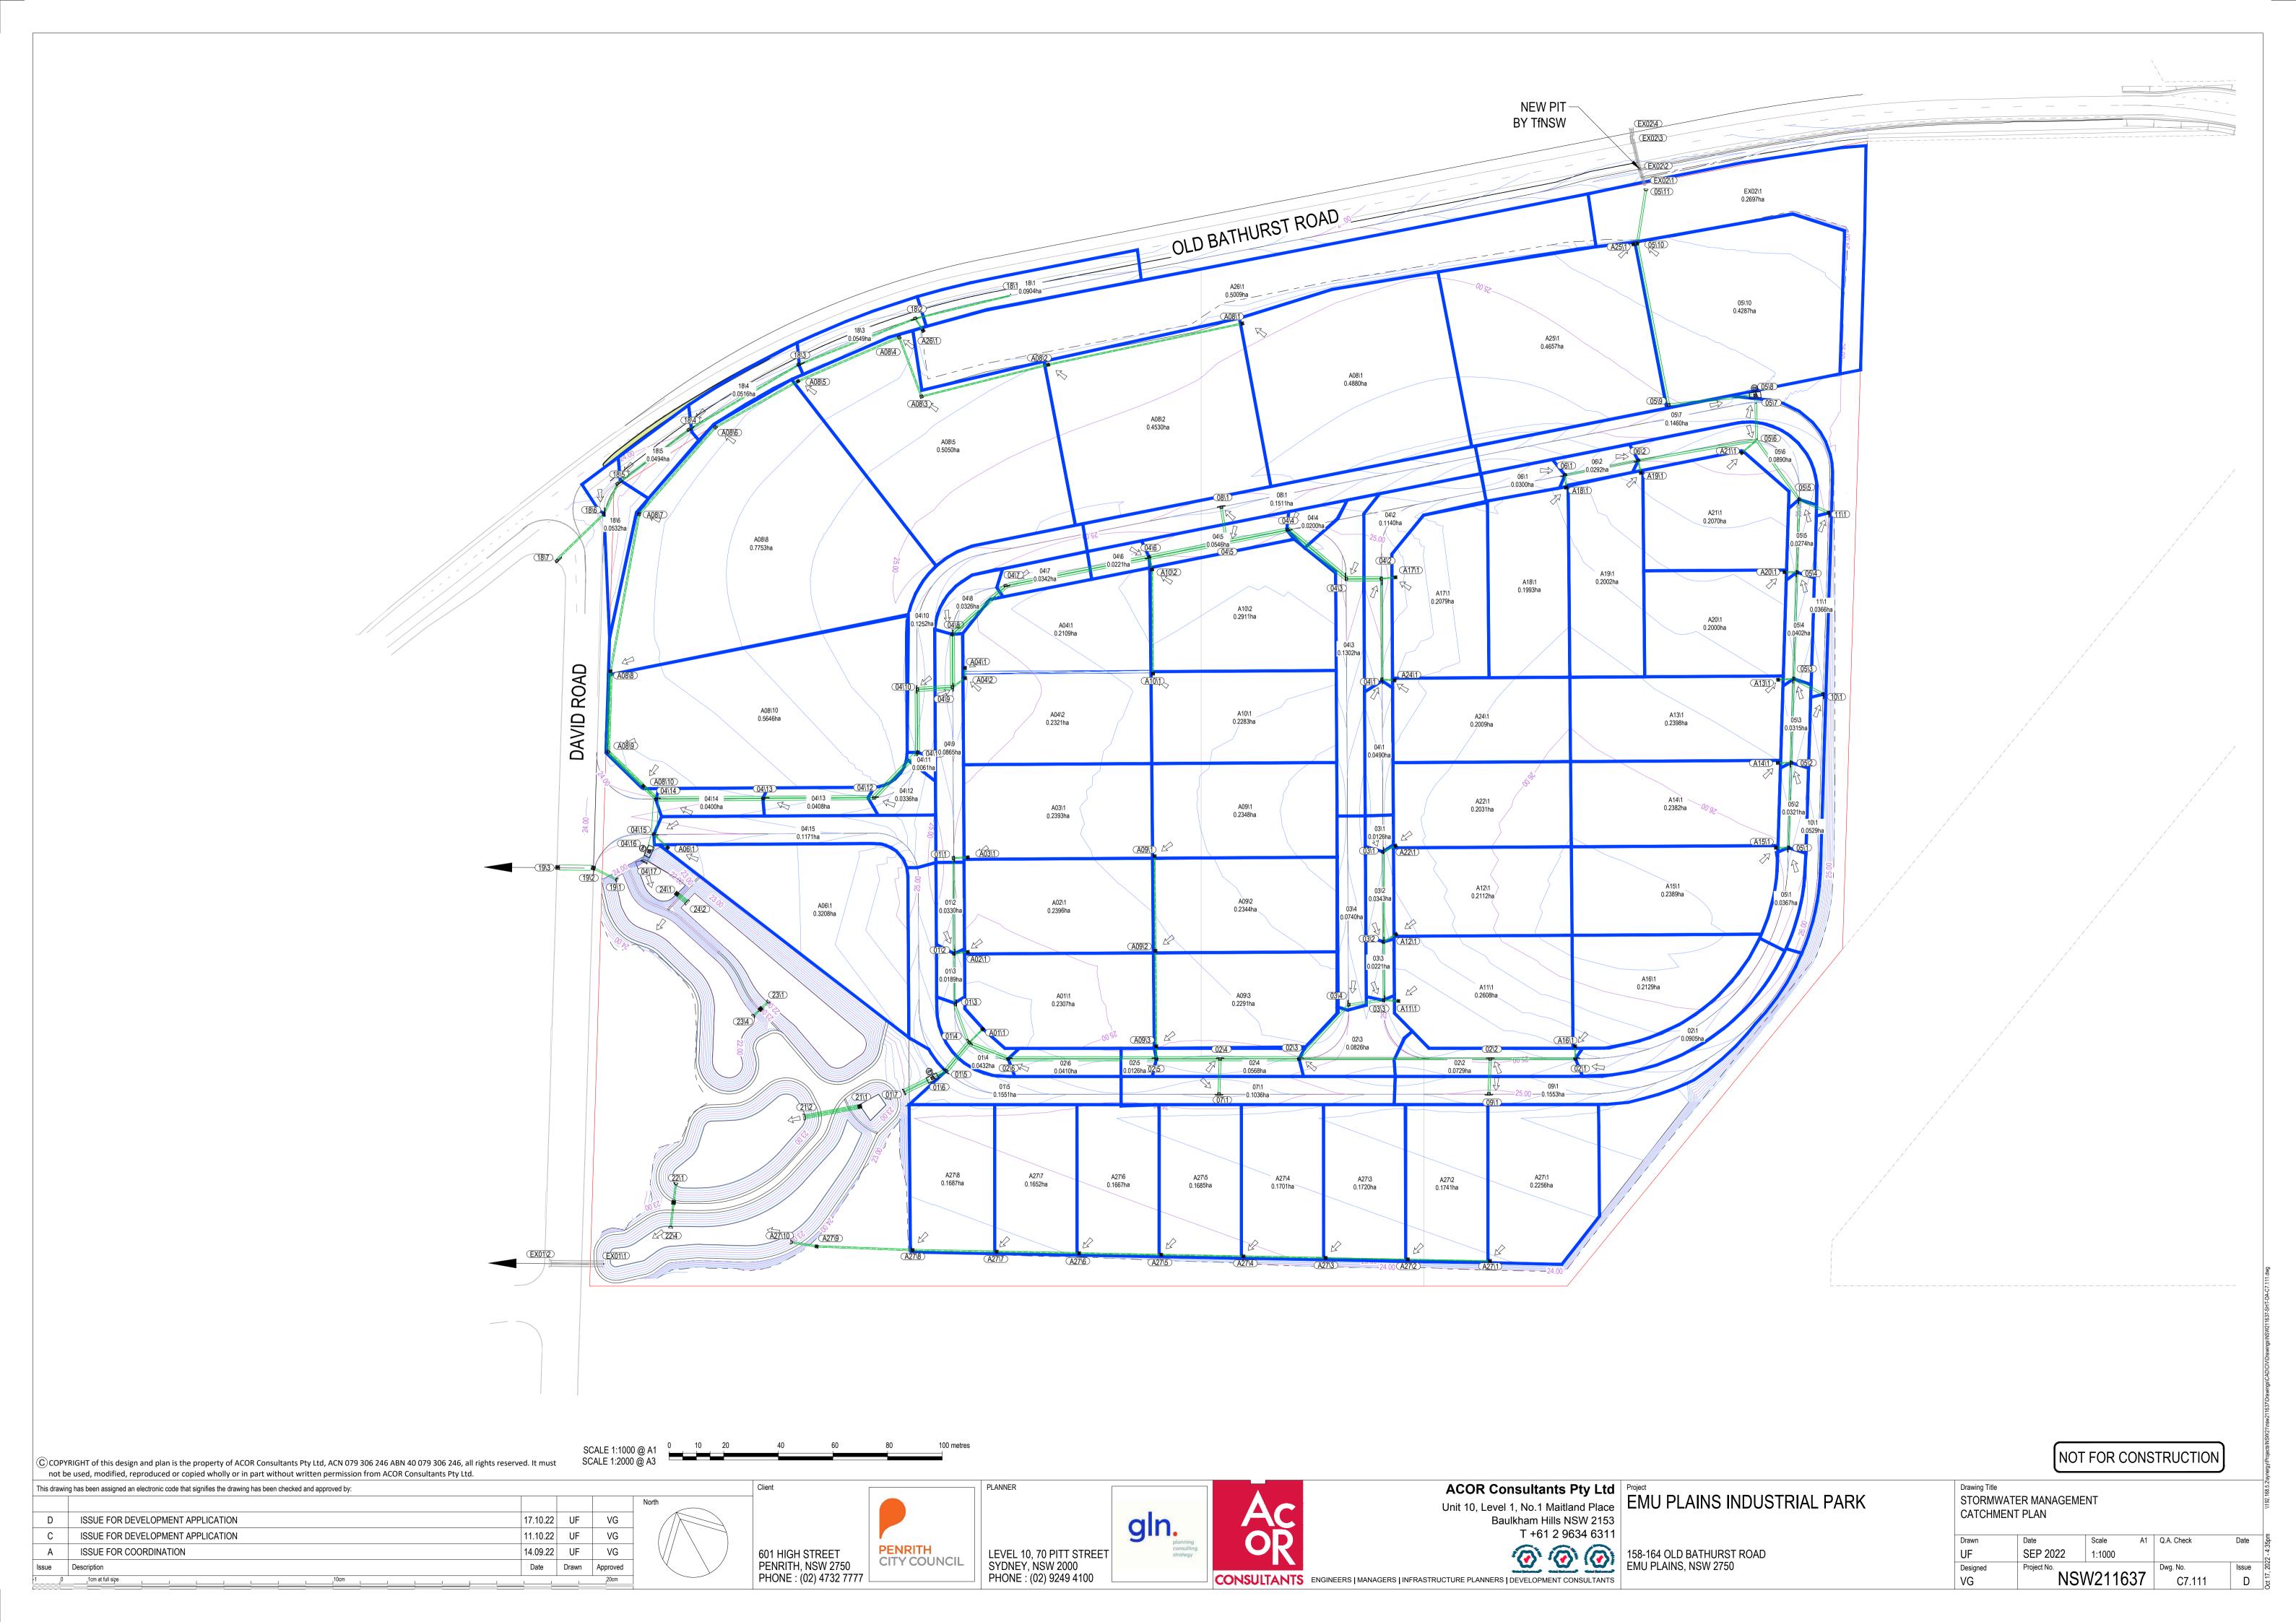


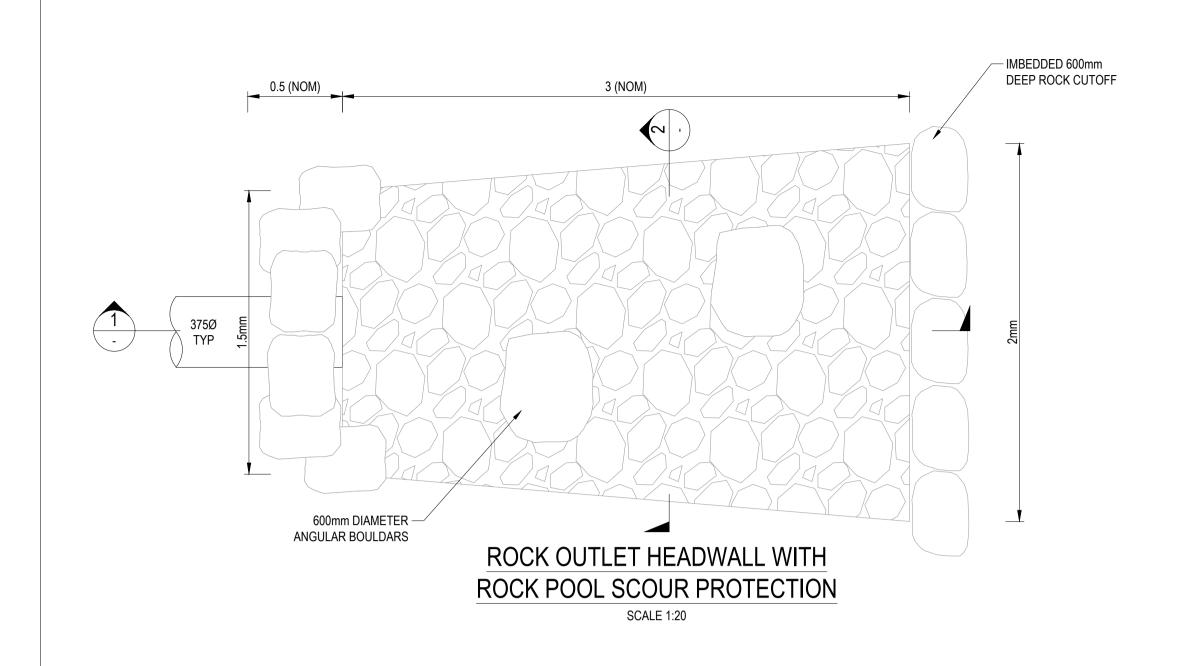


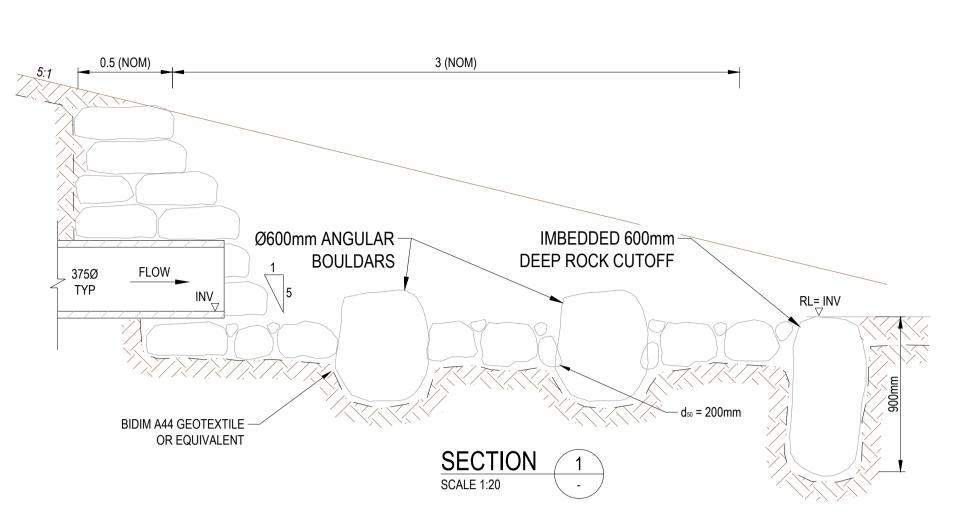


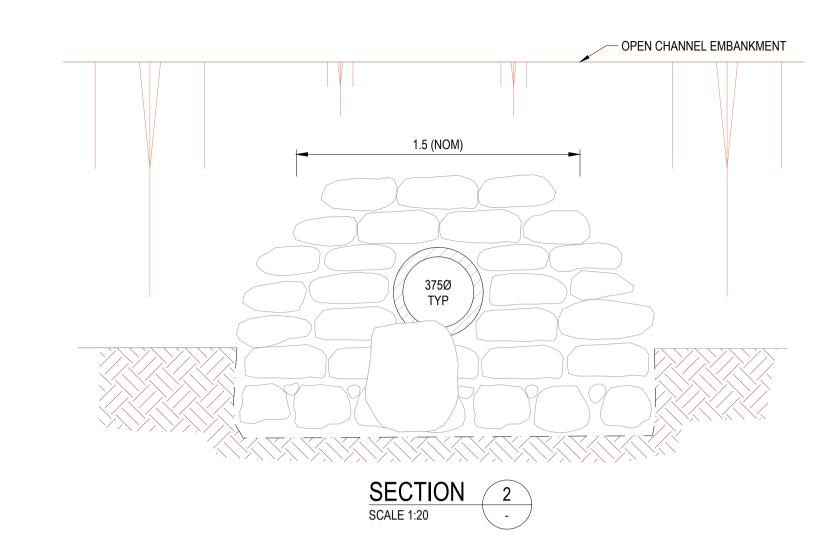


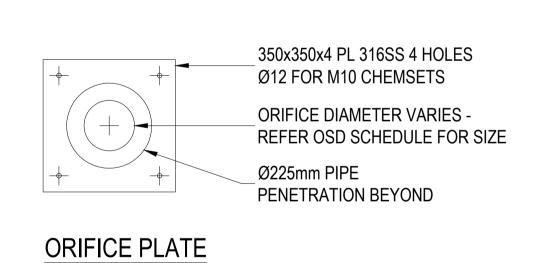


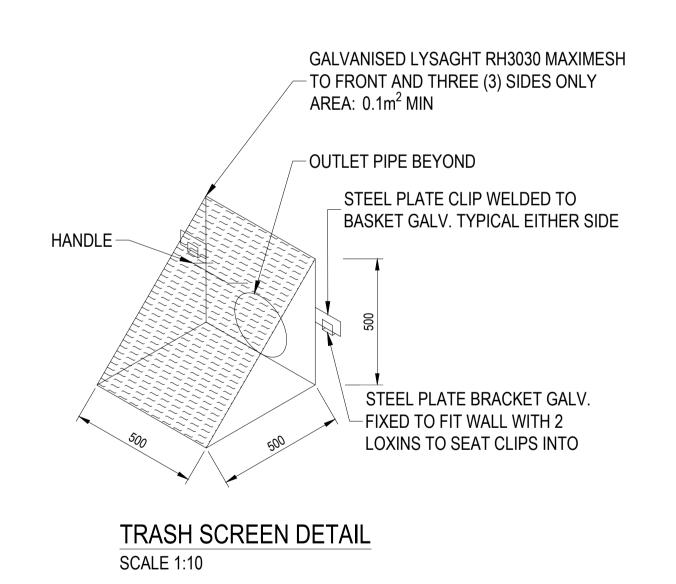













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SCALE 1:10 @ A1 SCALE 1:20 @ A3 PLANNER LEVEL 10, 70 PITT STREET SYDNEY, NSW 2000 PHONE : (02) 9249 4100 CITY COUNCIL

SCALE 1:10

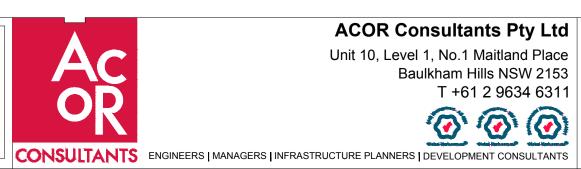gln.




ACOR Consultants Pty Ltd
Unit 10, Level 1, No.1 Maitland Place

Project
EMU PLAINS INDUSTRIAL PARK Baulkham Hills NSW 2153 T +61 2 9634 6311

NOT FOR CONSTRUCTION Drawing Title STORMWATER MANAGEMENT TYPICAL DETAILS

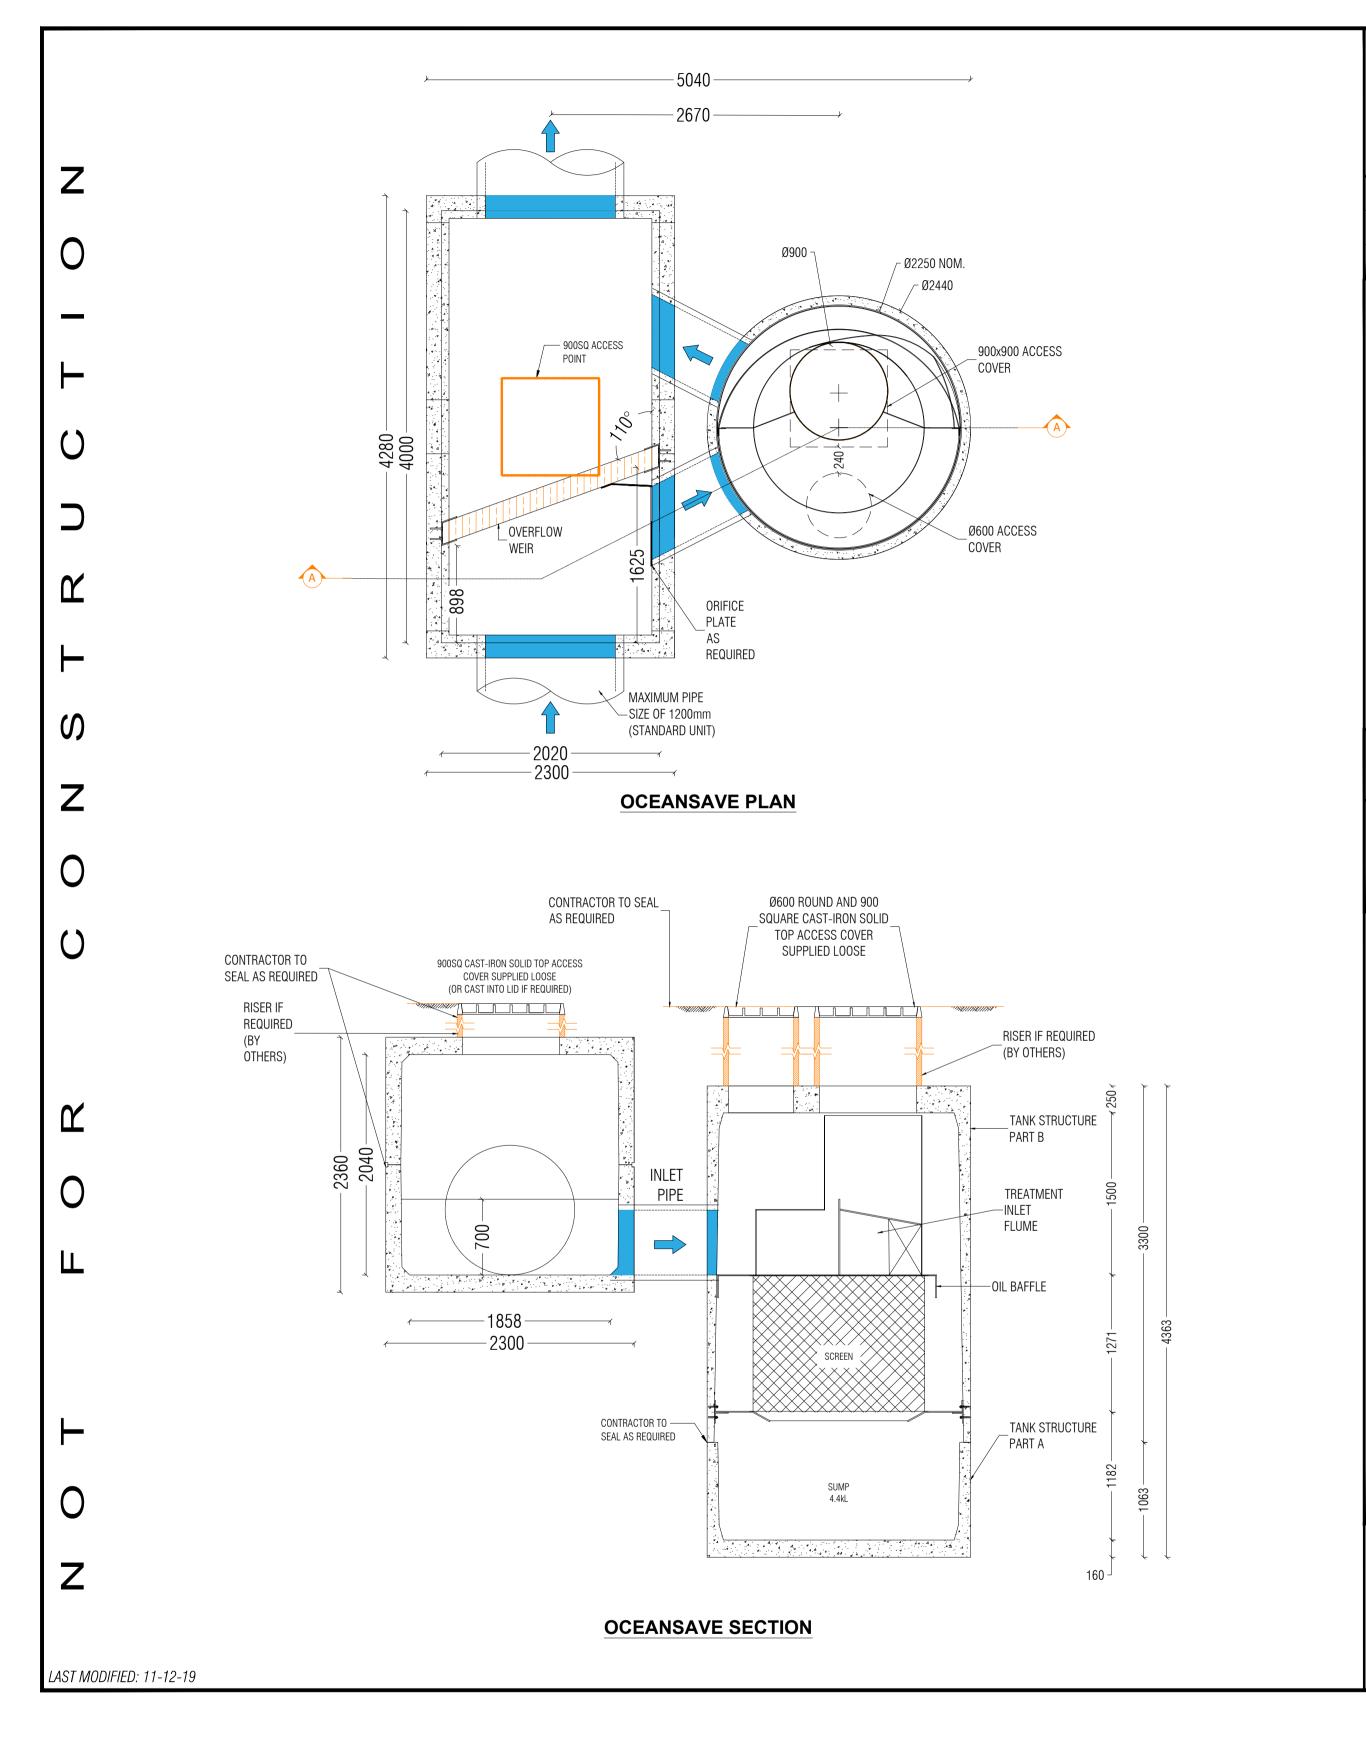
SHEET 1 Drawn A1 Q.A. Check Scale 158-164 OLD BATHURST ROAD EMU PLAINS, NSW 2750 UF SEP 2022 AS SHOWN Designed NSW211637 C7.201 VG



OCEANSAVE DESIGN TABLE

TO BE INSTALLED ONLINE THE TOTAL INLET PIPE FLOW RATE MUST BE LESS THAN THE SPECIFIED UNITS LISTED MAXIMUM TOTAL FLOW RATE; THE UNIT MUST BE PLACED OFFLINE WHERE THE INLET FLOW RATE EXCEEDS THIS VALUE.

TREATABLE FLOWRATE [L/s]	250
MAXIMUM TOTAL FLOWRATE [L/s]	3800
WEIR HEIGHT [mm]	700

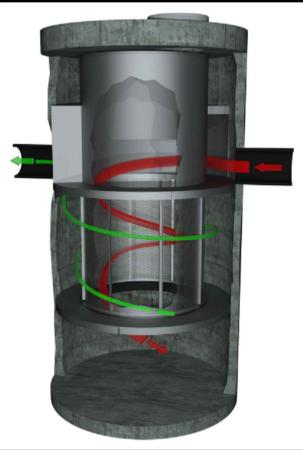

SITE SPECIFIC DATA REQUIREMENTS

FLOWRATE INTO DIVERSION CHAMBER[L/S]

PIPE DATA:	I.L.	MATERIAL	DIAMETER
INLET PIPE		[]	[]
OUTLET PIPE			

UPPER DIVERSION TANK WEIGHT	8567kg
LOWER DIVERSION TANK WEIGHT	8567kg
UPPER TANK WEIGHT	6760kg
UPPER TANK WEIGHT	4430kg

NOTE: TANK SUPPLIED IN TWO PARTS; PARTS A & B TO BE JOINED ON SITE

GENERAL NOTES

- 1. OCEANSAVE WATER QUALITY STRUCTURE SHALL BE IN ACCORDANCE WITH ALL DESIGN DATA AND INFORMATION CONTAINED IN THIS DRAWING. CONTRACTOR TO CONFIRM STRUCTURE MEETS REQUIREMENTS OF THE PROJECT.
- 2. PRECAST STRUCTURE SUPPLIED WITH CORE HOLES TO SUIT OUTER DIAMETER OF NOMINATED PIPE SIZE / MATERIAL.
- 3. PRECAST STRUCTURE SHALL MEET W80 WHEEL LOAD RATING ASSUMING A MAXIMUM EARTH COVER OF 1.5m AND A GROUND WATER ELEVATION AT, OR BELOW, THE OUTLET PIPE INVERT ELEVATION. ENGINEER TO CONFIRM ACTUAL GROUNDWATER ELEVATION.PRECAST STRUCTURE SHALL BE IN ACCORDANCE WITH AS3600.
- 4. ALL WATER QUALITY TREATMENT DEVICES REQUIRE PERIODIC MAINTENANCE. REFER TO OPERATION AND MAINTENANCE MANUAL FOR GUIDELINES AND ACCESS REQUIREMENTS.
- 5. SITE SPECIFIC PRODUCTION DRAWING WILL BE PROVIDED ON PLACEMENT OF ORDER.
- 6. DRAWING NOT TO SCALE.

INSTALLATION NOTES

- A. ANY SUB-BASE, BACKFILL DEPTH, AND/OR ANTI-FLOTATION PROVISIONS ARE SITE SPECIFIC DESIGN CONSIDERATION AND SHALL BE SPECIFIED BY THE SITE CIVIL ENGINEER.
- B. CONTRACTOR TO PROVIDE ALL EQUIPMENT WITH SUFFICIENT LIFTING AND REACH CAPACITY TO LIFT AND SET THE STRUCTURE (LIFTING DETAIL PROVIDED SEPARATELY).
- C. CONTRACTOR TO INSTALL AND LEVEL THE STRUCTURE, APPLY SEALANT TO ALL JOINTS AND TO PROVIDE, INSTALL AND GROUT INLET AND OUTLET PIPES.
- D. CONTRACTOR TO TAKE APPROPRIATE MEASURES TO PROTECT SCREEN & SEPARATION CYLINDER COMPONENTS DURING INSTALLATION



OCEAN PROTECT OCEANSAVE 1612 OFFLINE SPECIFICATION DRAWING

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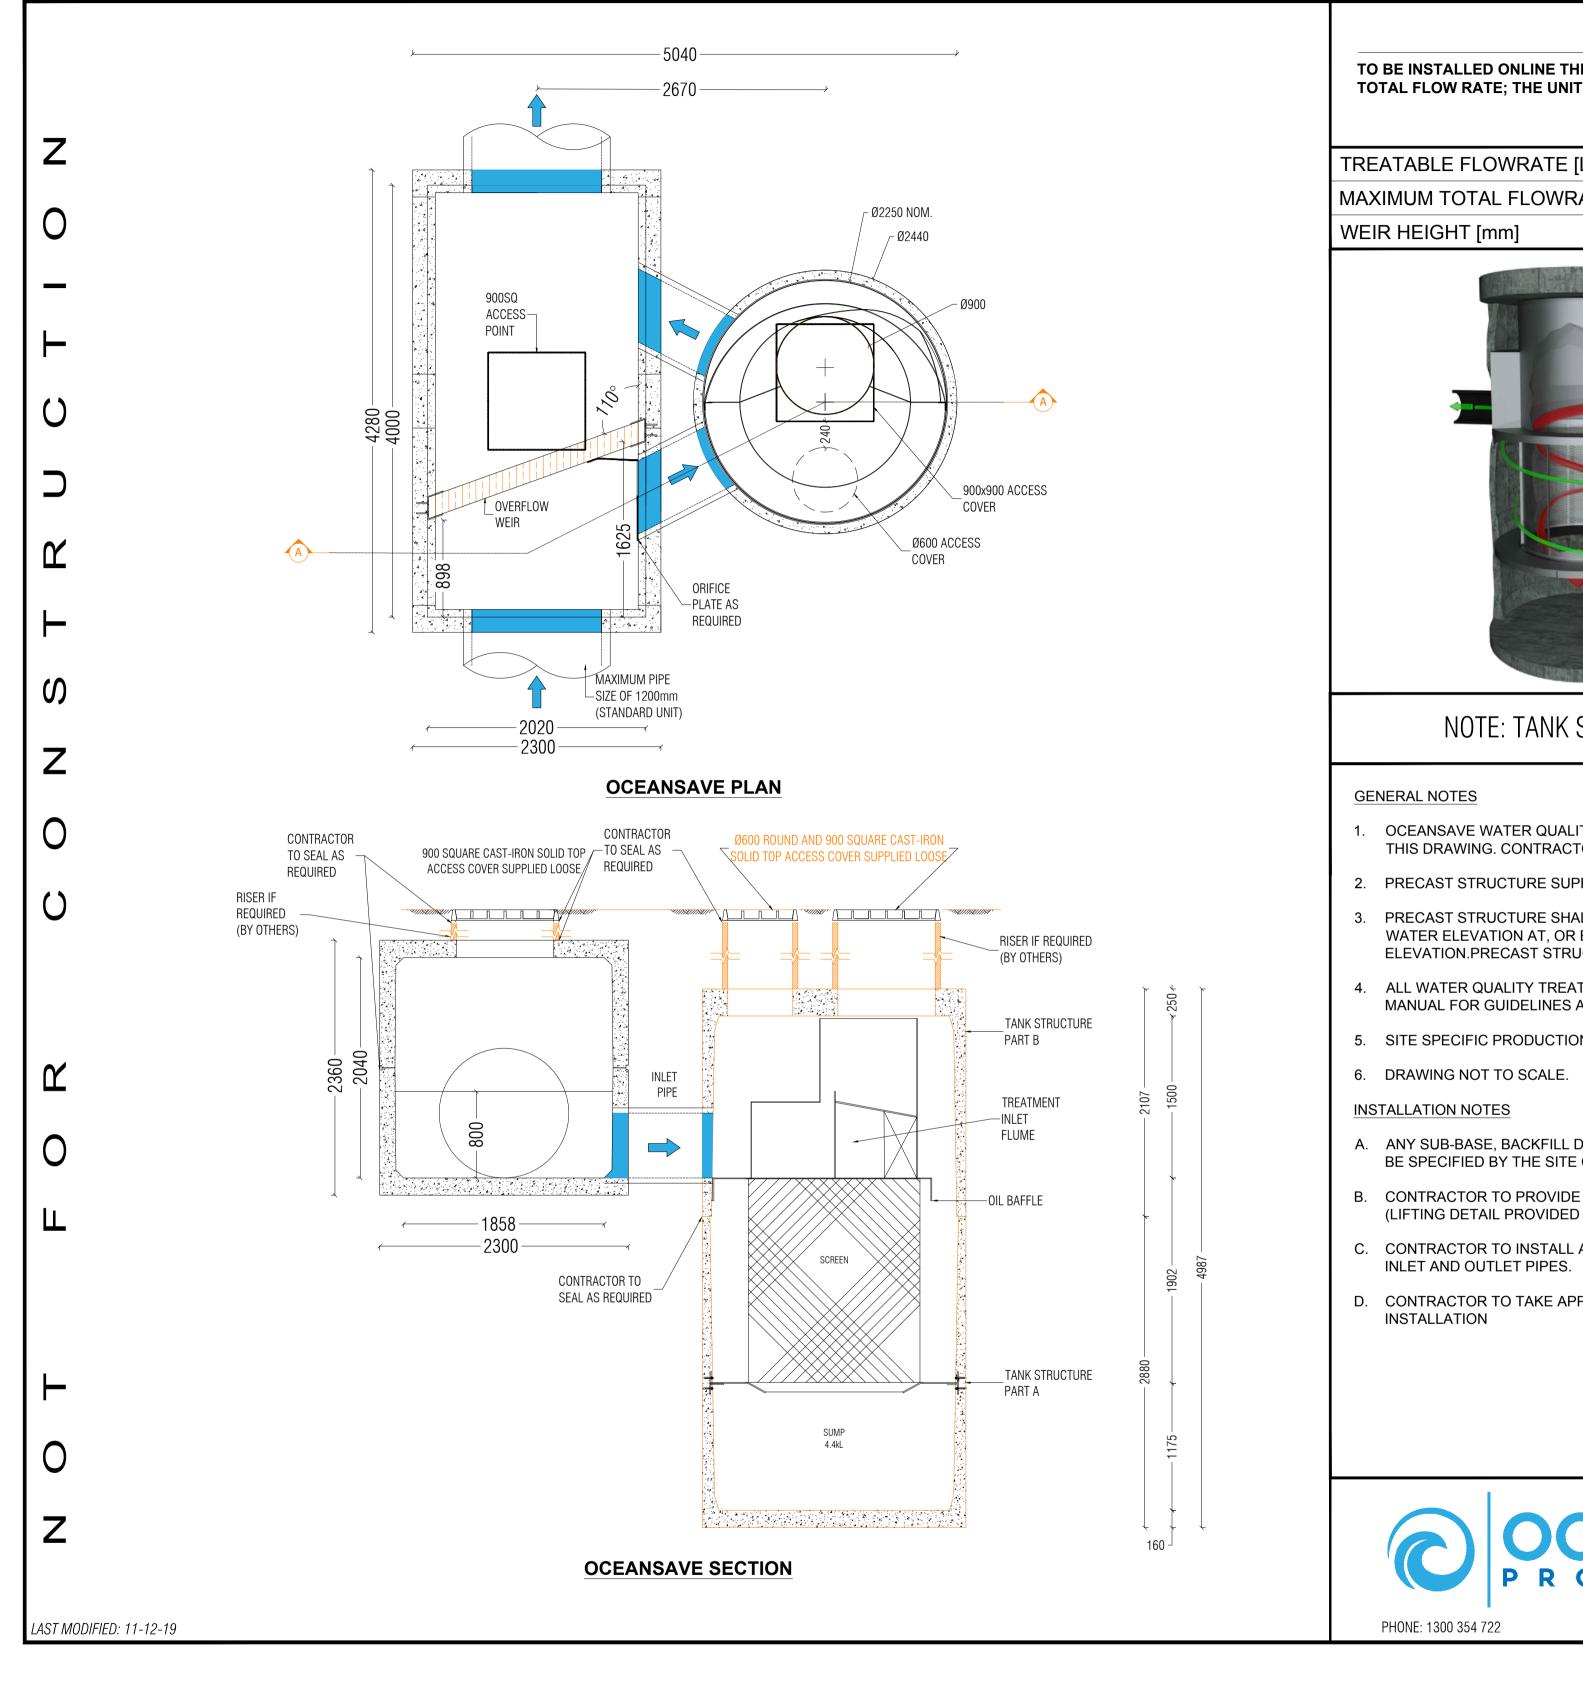
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Unit 10, Level 1, No.1 Maitland Place EMU PLAINS INDUSTRIAL PARK

UF SEP 2022

STORMWATER MANAGEMENT TYPICAL DETAILS SHEET 2 A1 Q.A. Check NOT TO SCALE Designed NSW211637 VG C7.202


NOT FOR CONSTRUCTION



OCEANSAVE DESIGN TABLE

TO BE INSTALLED ONLINE THE TOTAL INLET PIPE FLOW RATE MUST BE LESS THAN THE SPECIFIED UNITS LISTED MAXIMUM TOTAL FLOW RATE; THE UNIT MUST BE PLACED OFFLINE WHERE THE INLET FLOW RATE EXCEEDS THIS VALUE.

TREATABLE FLOWRATE [L/s]	350
MAXIMUM TOTAL FLOWRATE [L/s]	3800
WEIR HEIGHT [mm]	800

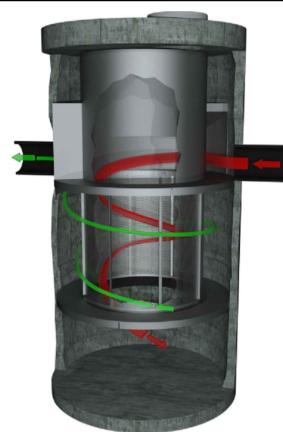

SITE SPECIFIC DATA REQUIREMENTS

FLOWRATE INTO DIVERSION CHAMBER[L/S]

PIPE DATA:	I.L.	MATERIAL	DIAMETER
INLET PIPE	[]		
OUTLET PIPE		[]	

UPPER DIVERSION TANK WEIGHT	8567kg
LOWER DIVERSION TANK WEIGHT	8567kg
UPPER TANK WEIGHT	6760kg
UPPER TANK WEIGHT	4430kg

NOTE: TANK SUPPLIED IN TWO PARTS; PARTS A & B TO BE JOINED ON SITE

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- 2. PRECAST STRUCTURE SUPPLIED WITH CORE HOLES TO SUIT OUTER DIAMETER OF NOMINATED PIPE SIZE / MATERIAL.
- PRECAST STRUCTURE SHALL MEET W80 WHEEL LOAD RATING ASSUMING A MAXIMUM EARTH COVER OF 1.5m AND A GROUND WATER ELEVATION AT, OR BELOW, THE OUTLET PIPE INVERT ELEVATION. ENGINEER TO CONFIRM ACTUAL GROUNDWATER ELEVATION.PRECAST STRUCTURE SHALL BE IN ACCORDANCE WITH AS3600.
- ALL WATER QUALITY TREATMENT DEVICES REQUIRE PERIODIC MAINTENANCE. REFER TO OPERATION AND MAINTENANCE MANUAL FOR GUIDELINES AND ACCESS REQUIREMENTS.
- 5. SITE SPECIFIC PRODUCTION DRAWING WILL BE PROVIDED ON PLACEMENT OF ORDER.
- A. ANY SUB-BASE, BACKFILL DEPTH, AND/OR ANTI-FLOTATION PROVISIONS ARE SITE SPECIFIC DESIGN CONSIDERATION AND SHALL BE SPECIFIED BY THE SITE CIVIL ENGINEER.
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- C. CONTRACTOR TO INSTALL AND LEVEL THE STRUCTURE, APPLY SEALANT TO ALL JOINTS AND TO PROVIDE, INSTALL AND GROUT
- D. CONTRACTOR TO TAKE APPROPRIATE MEASURES TO PROTECT SCREEN & SEPARATION CYLINDER COMPONENTS DURING



OCEAN PROTECT OCEANSAVE 1618 OFFLINE SPECIFICATION DRAWING

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Unit 10, Level 1, No.1 Maitland Place EMU PLAINS INDUSTRIAL PARK

VG


STORMWATER MANAGEMENT TYPICAL DETAILS SHEET 3 A1 Q.A. Check UF SEP 2022 NOT TO SCALE Designed

NSW211637

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C7.203
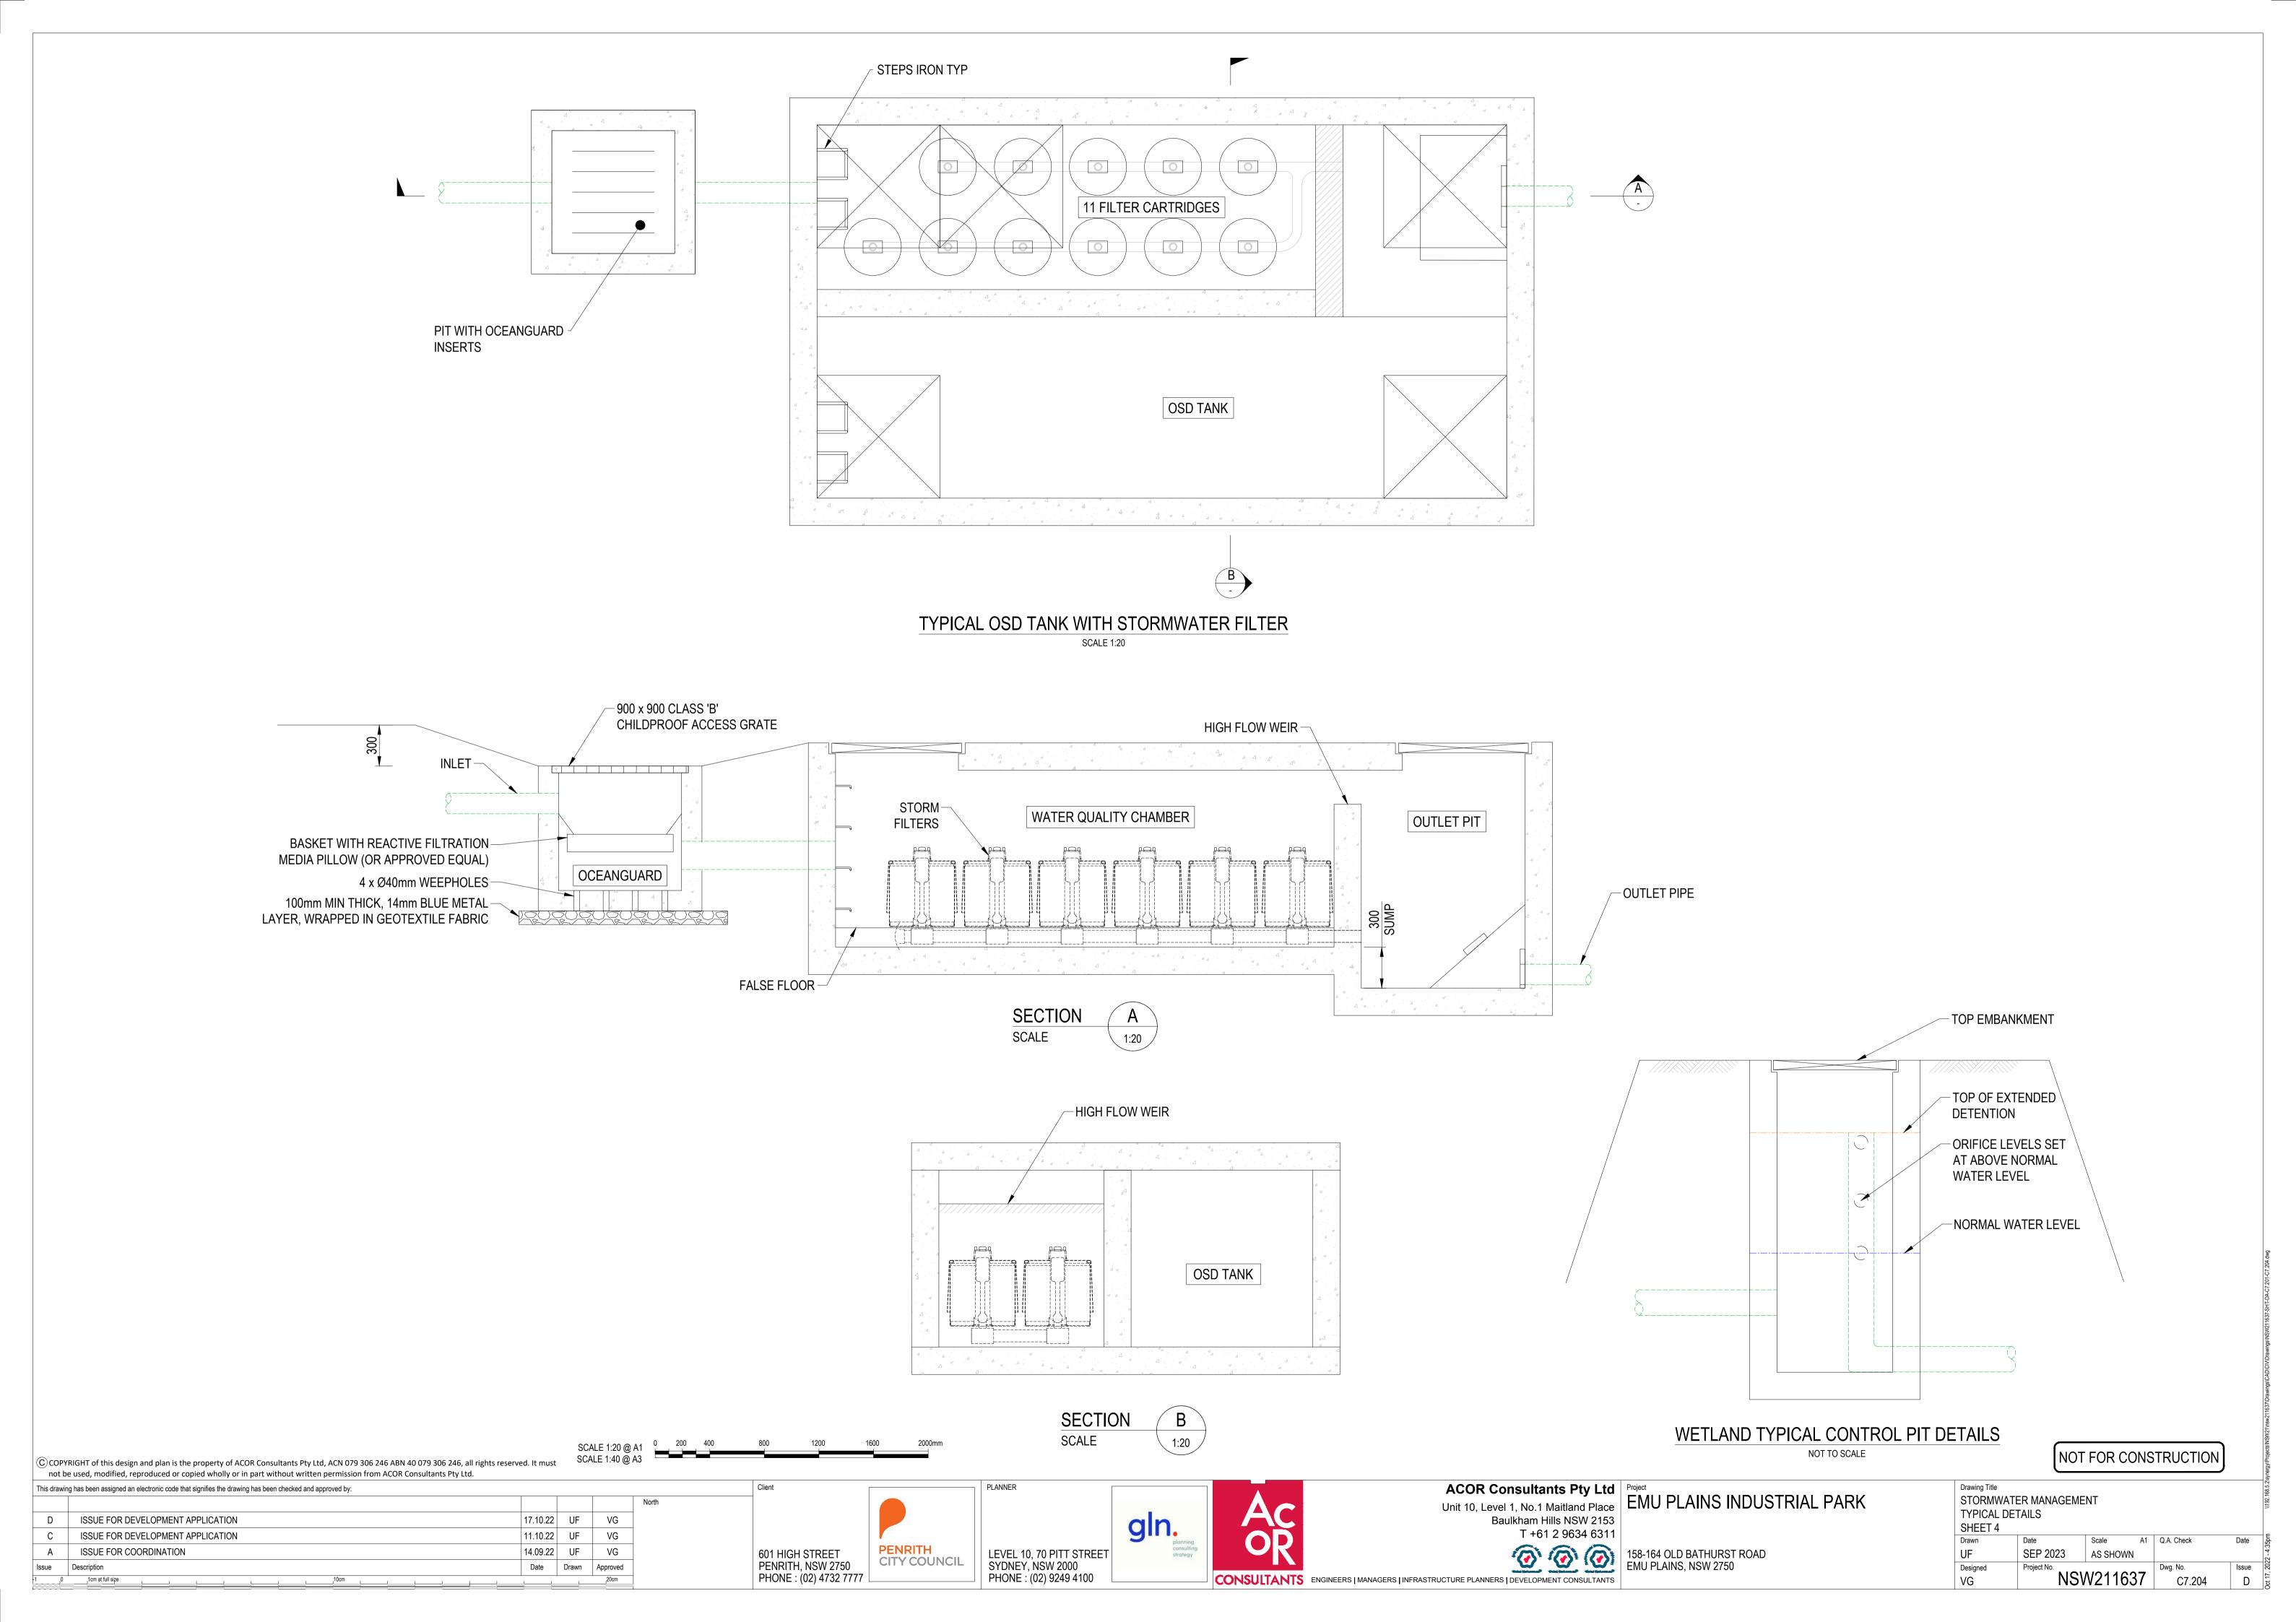
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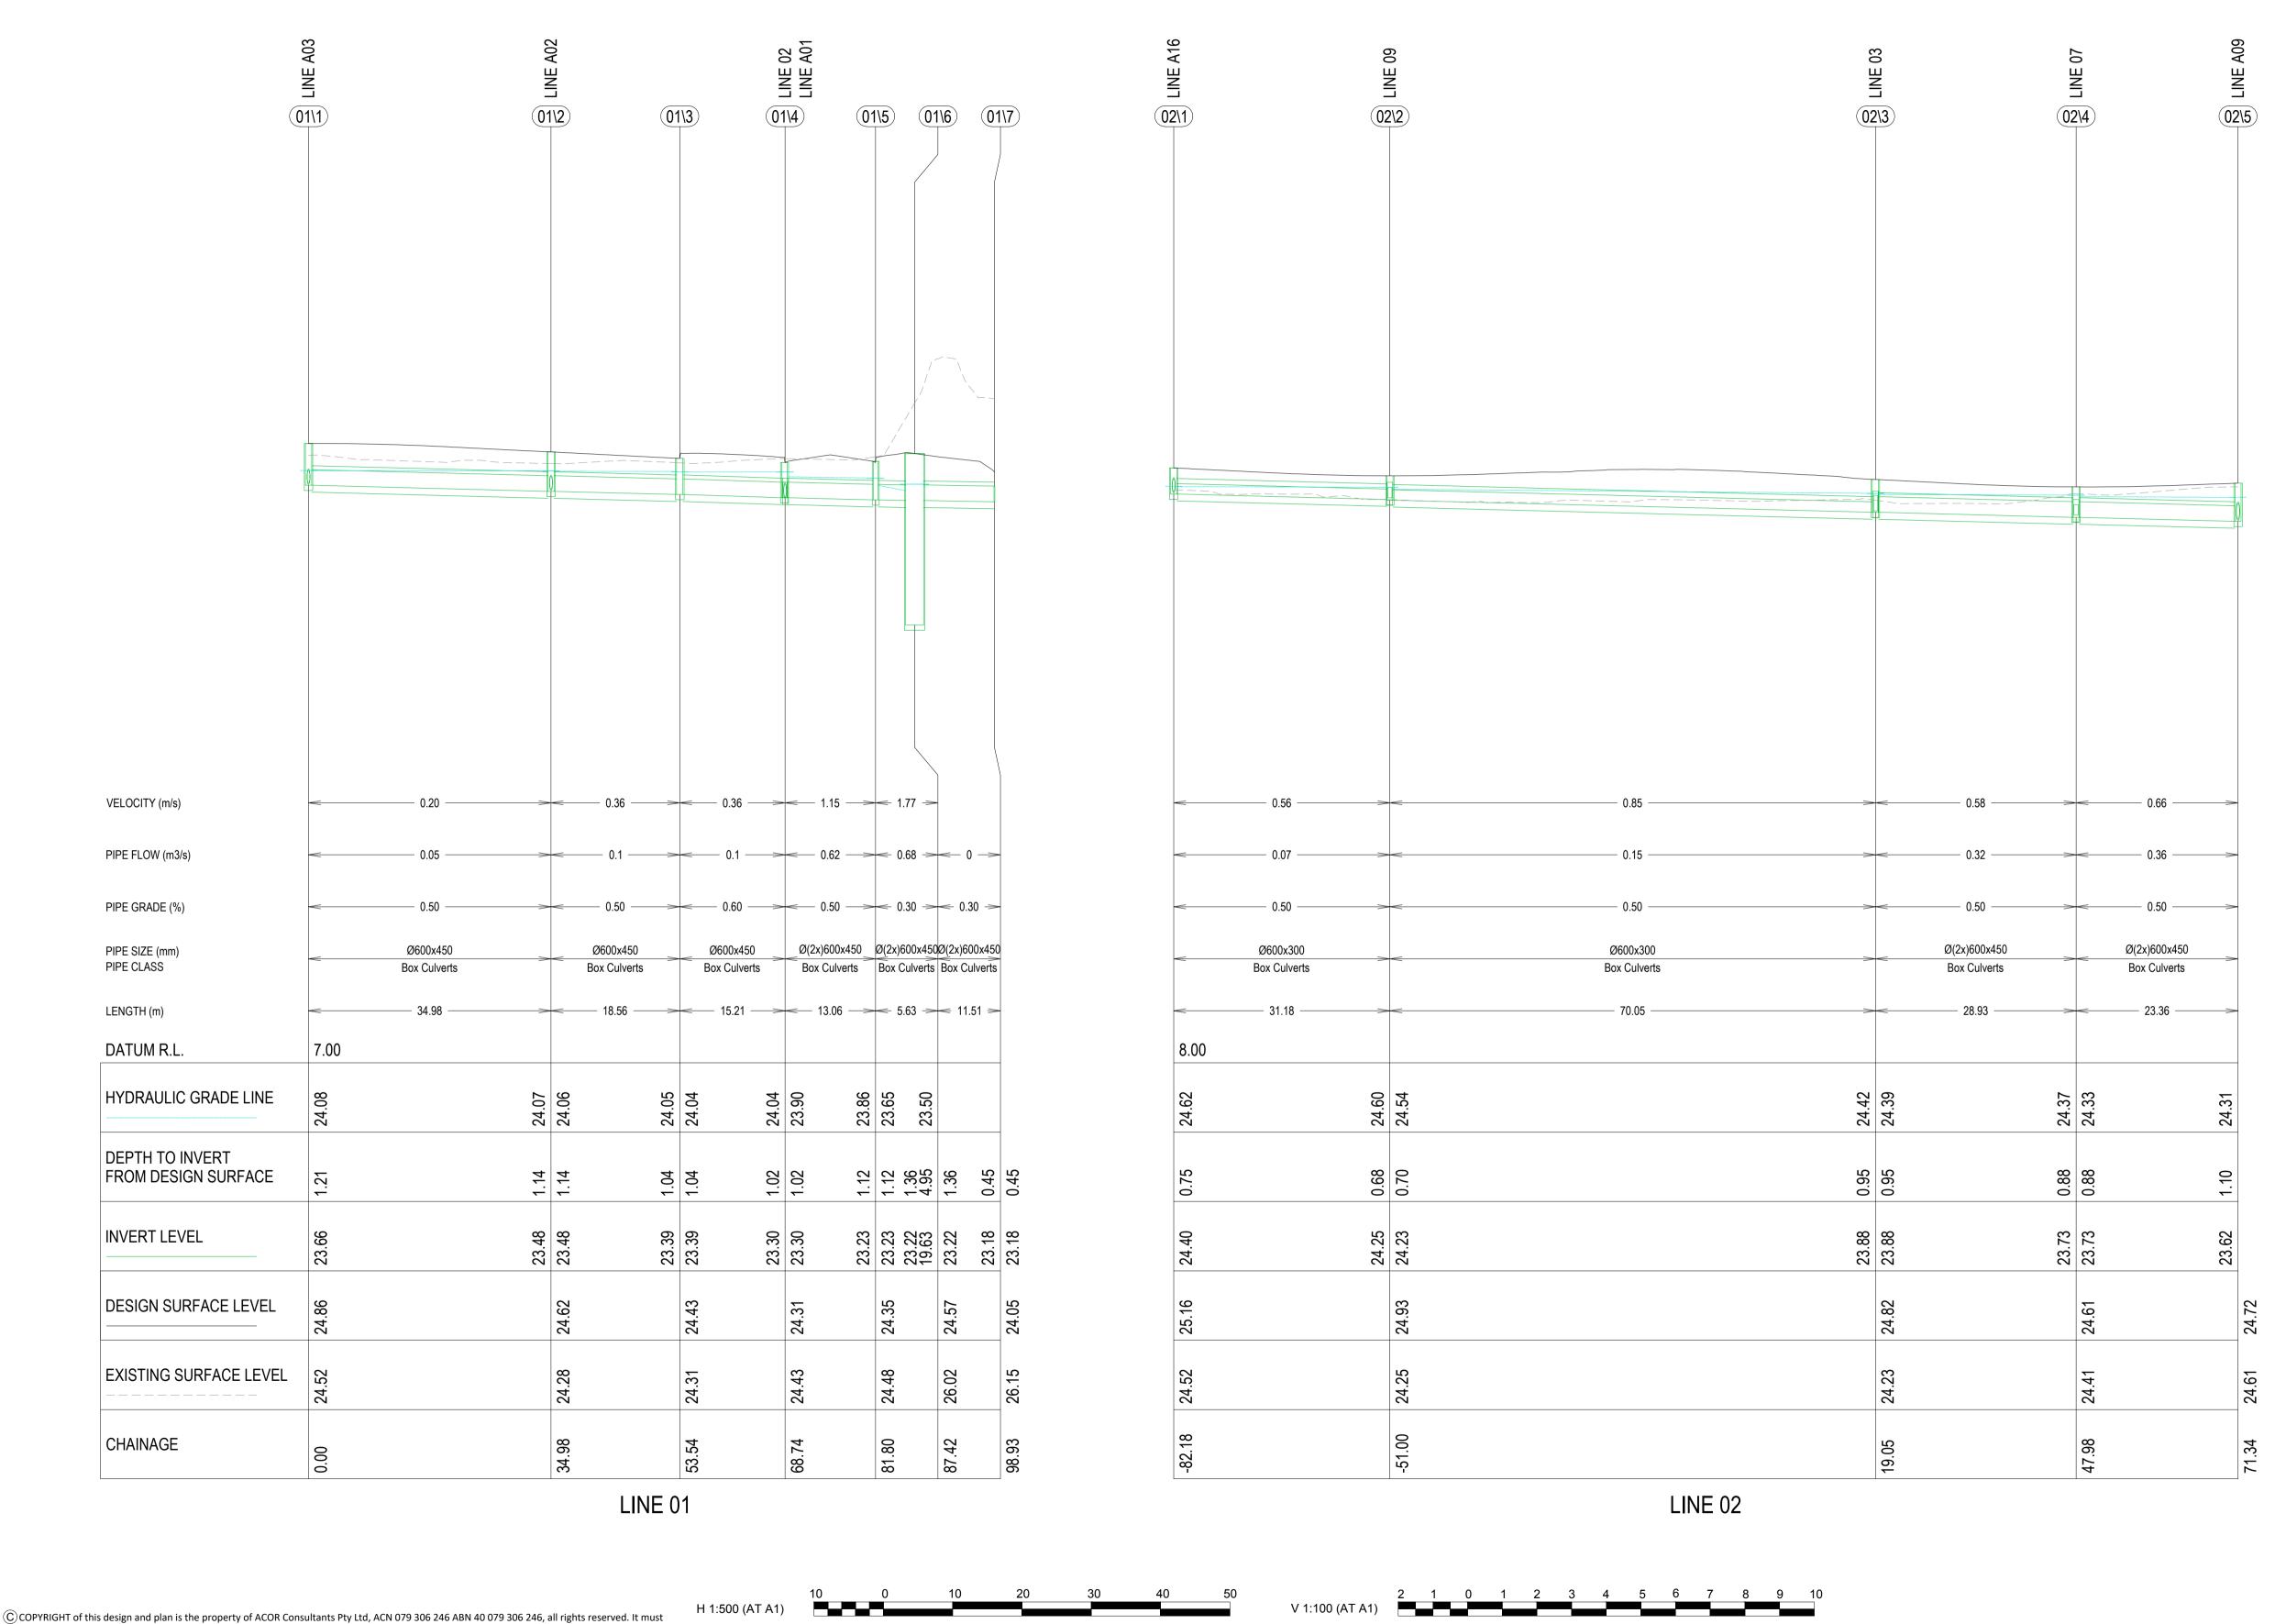
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ISSUE FOR DEVELOPMENT APPLICATION



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11.10.22 UF

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Unit 10, Level 1, No.1 Maitland Place

Project
EMU PLAINS INDUSTRIAL PARK Drawing Title STORMWATER MANAGEMENT LONGITUDINAL SECTION SHEET 1 A1 Q.A. Check

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PLANNER

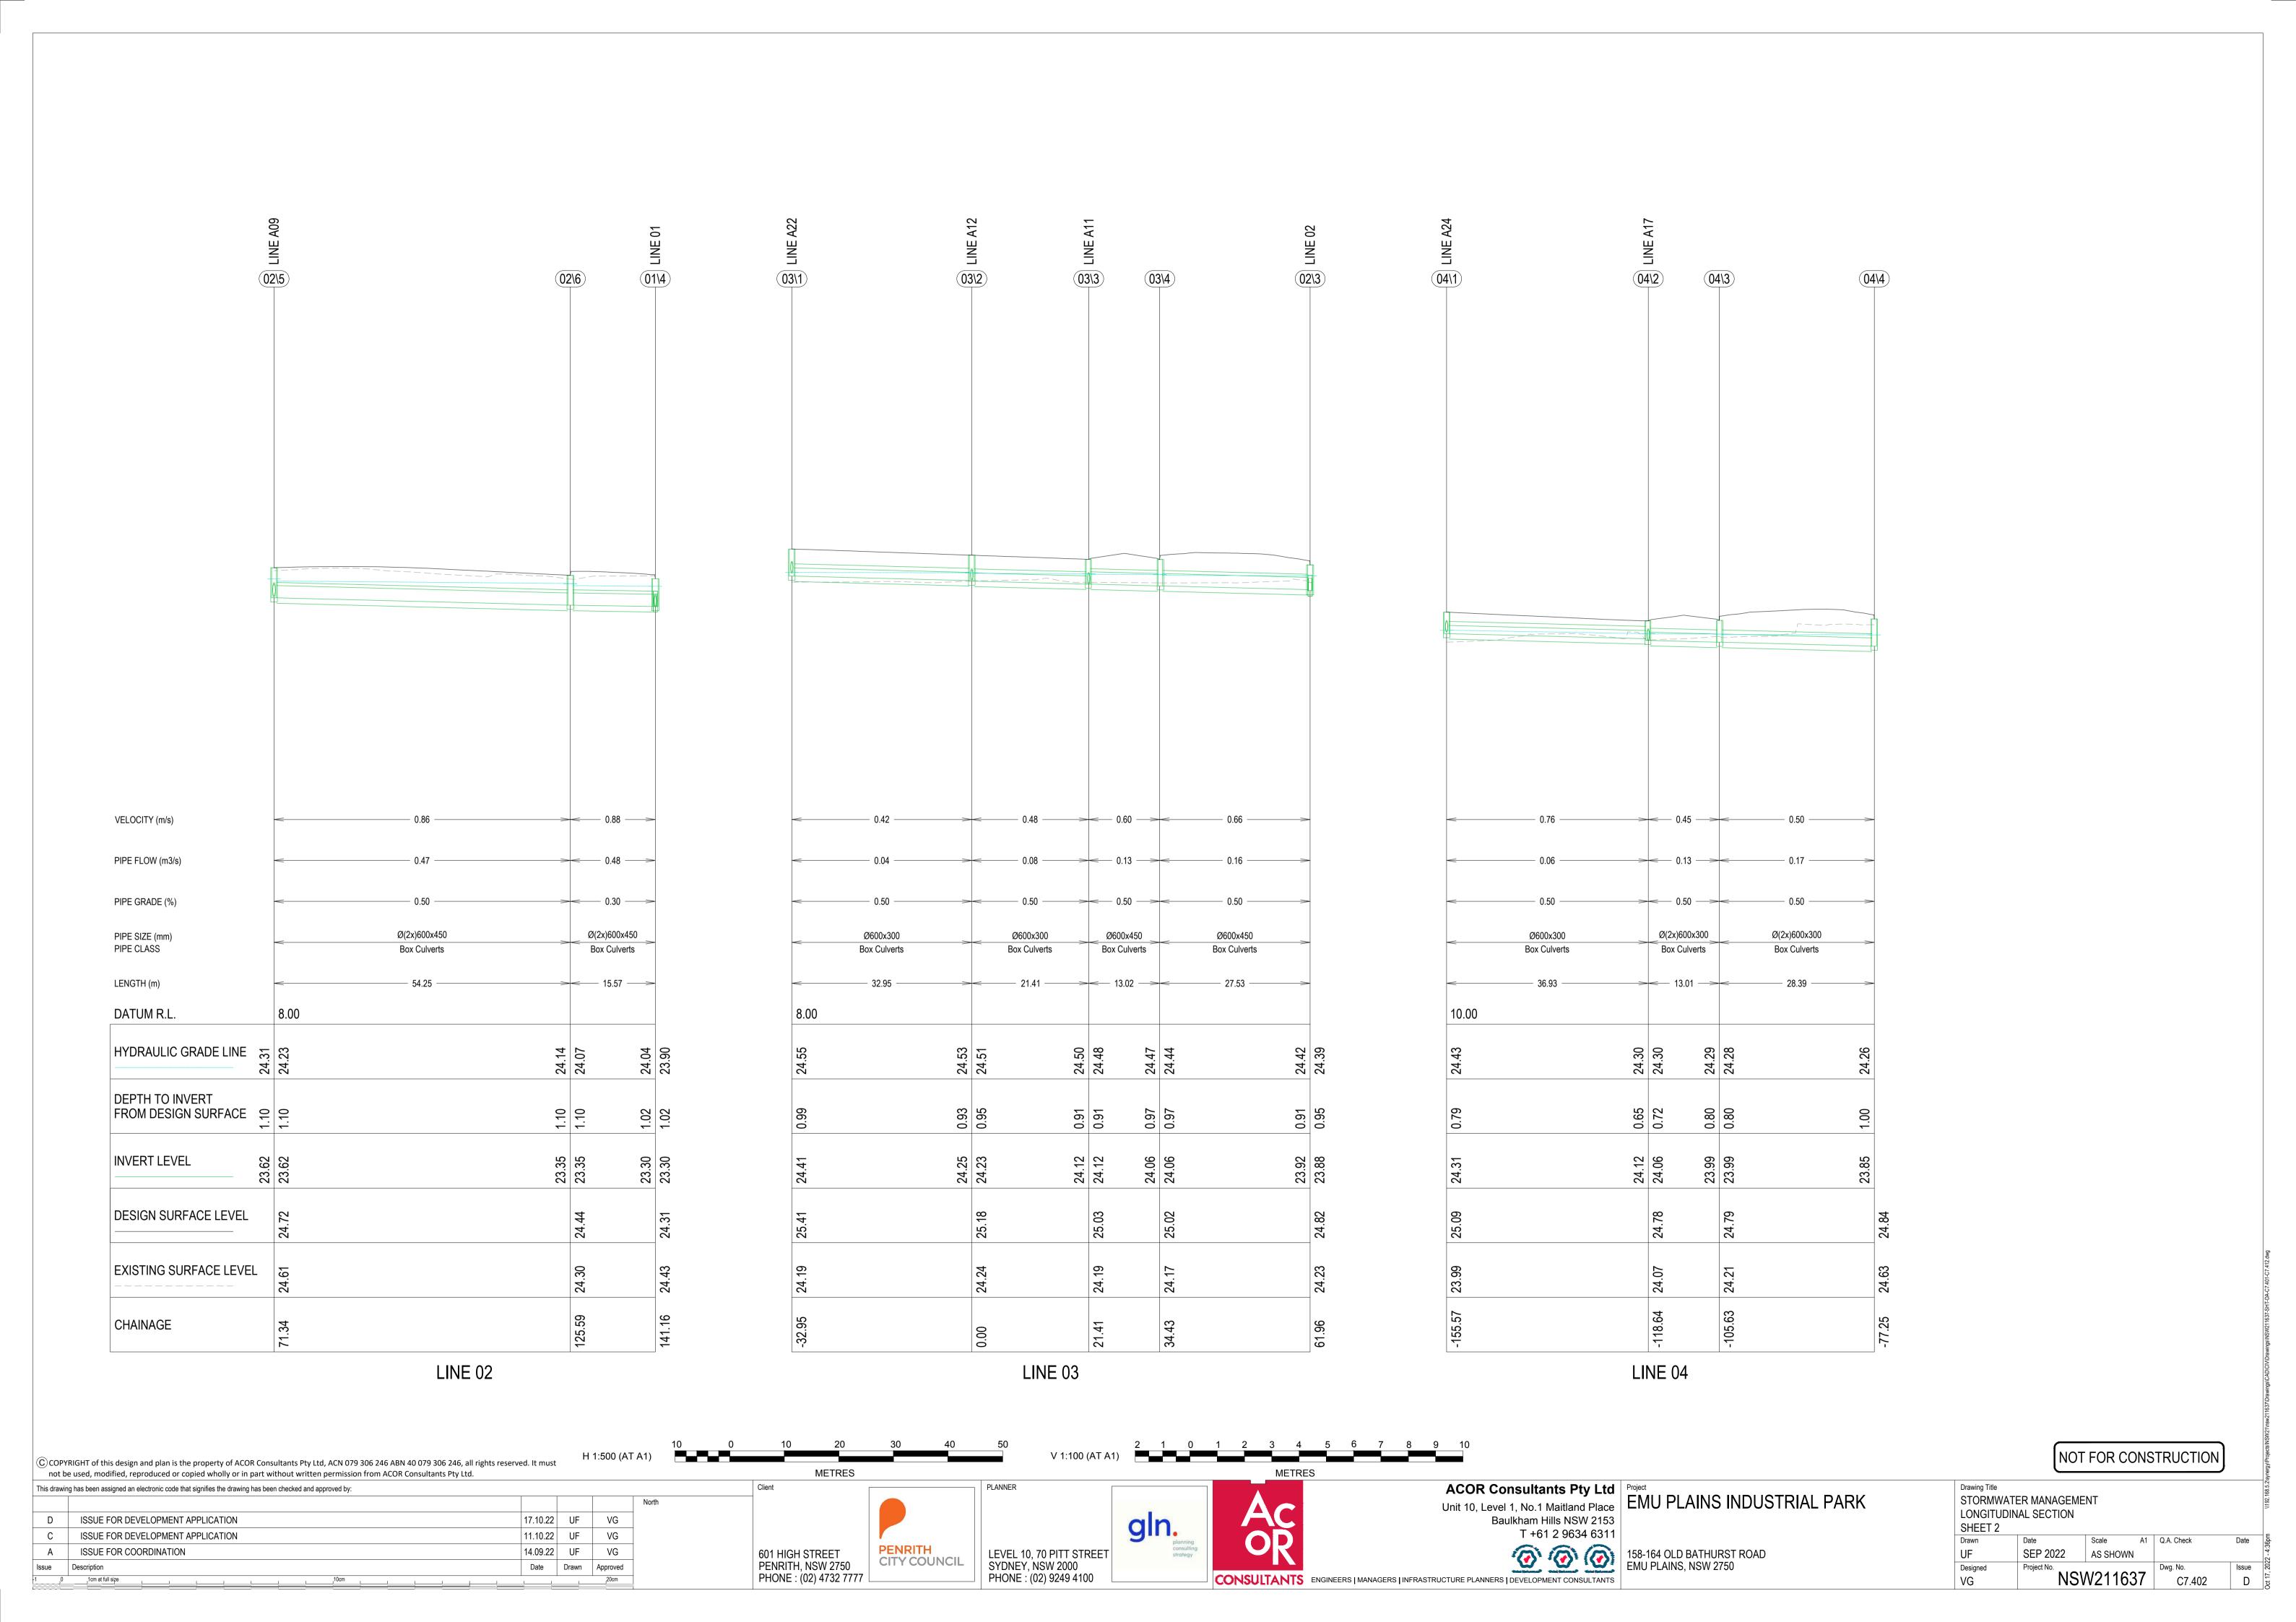
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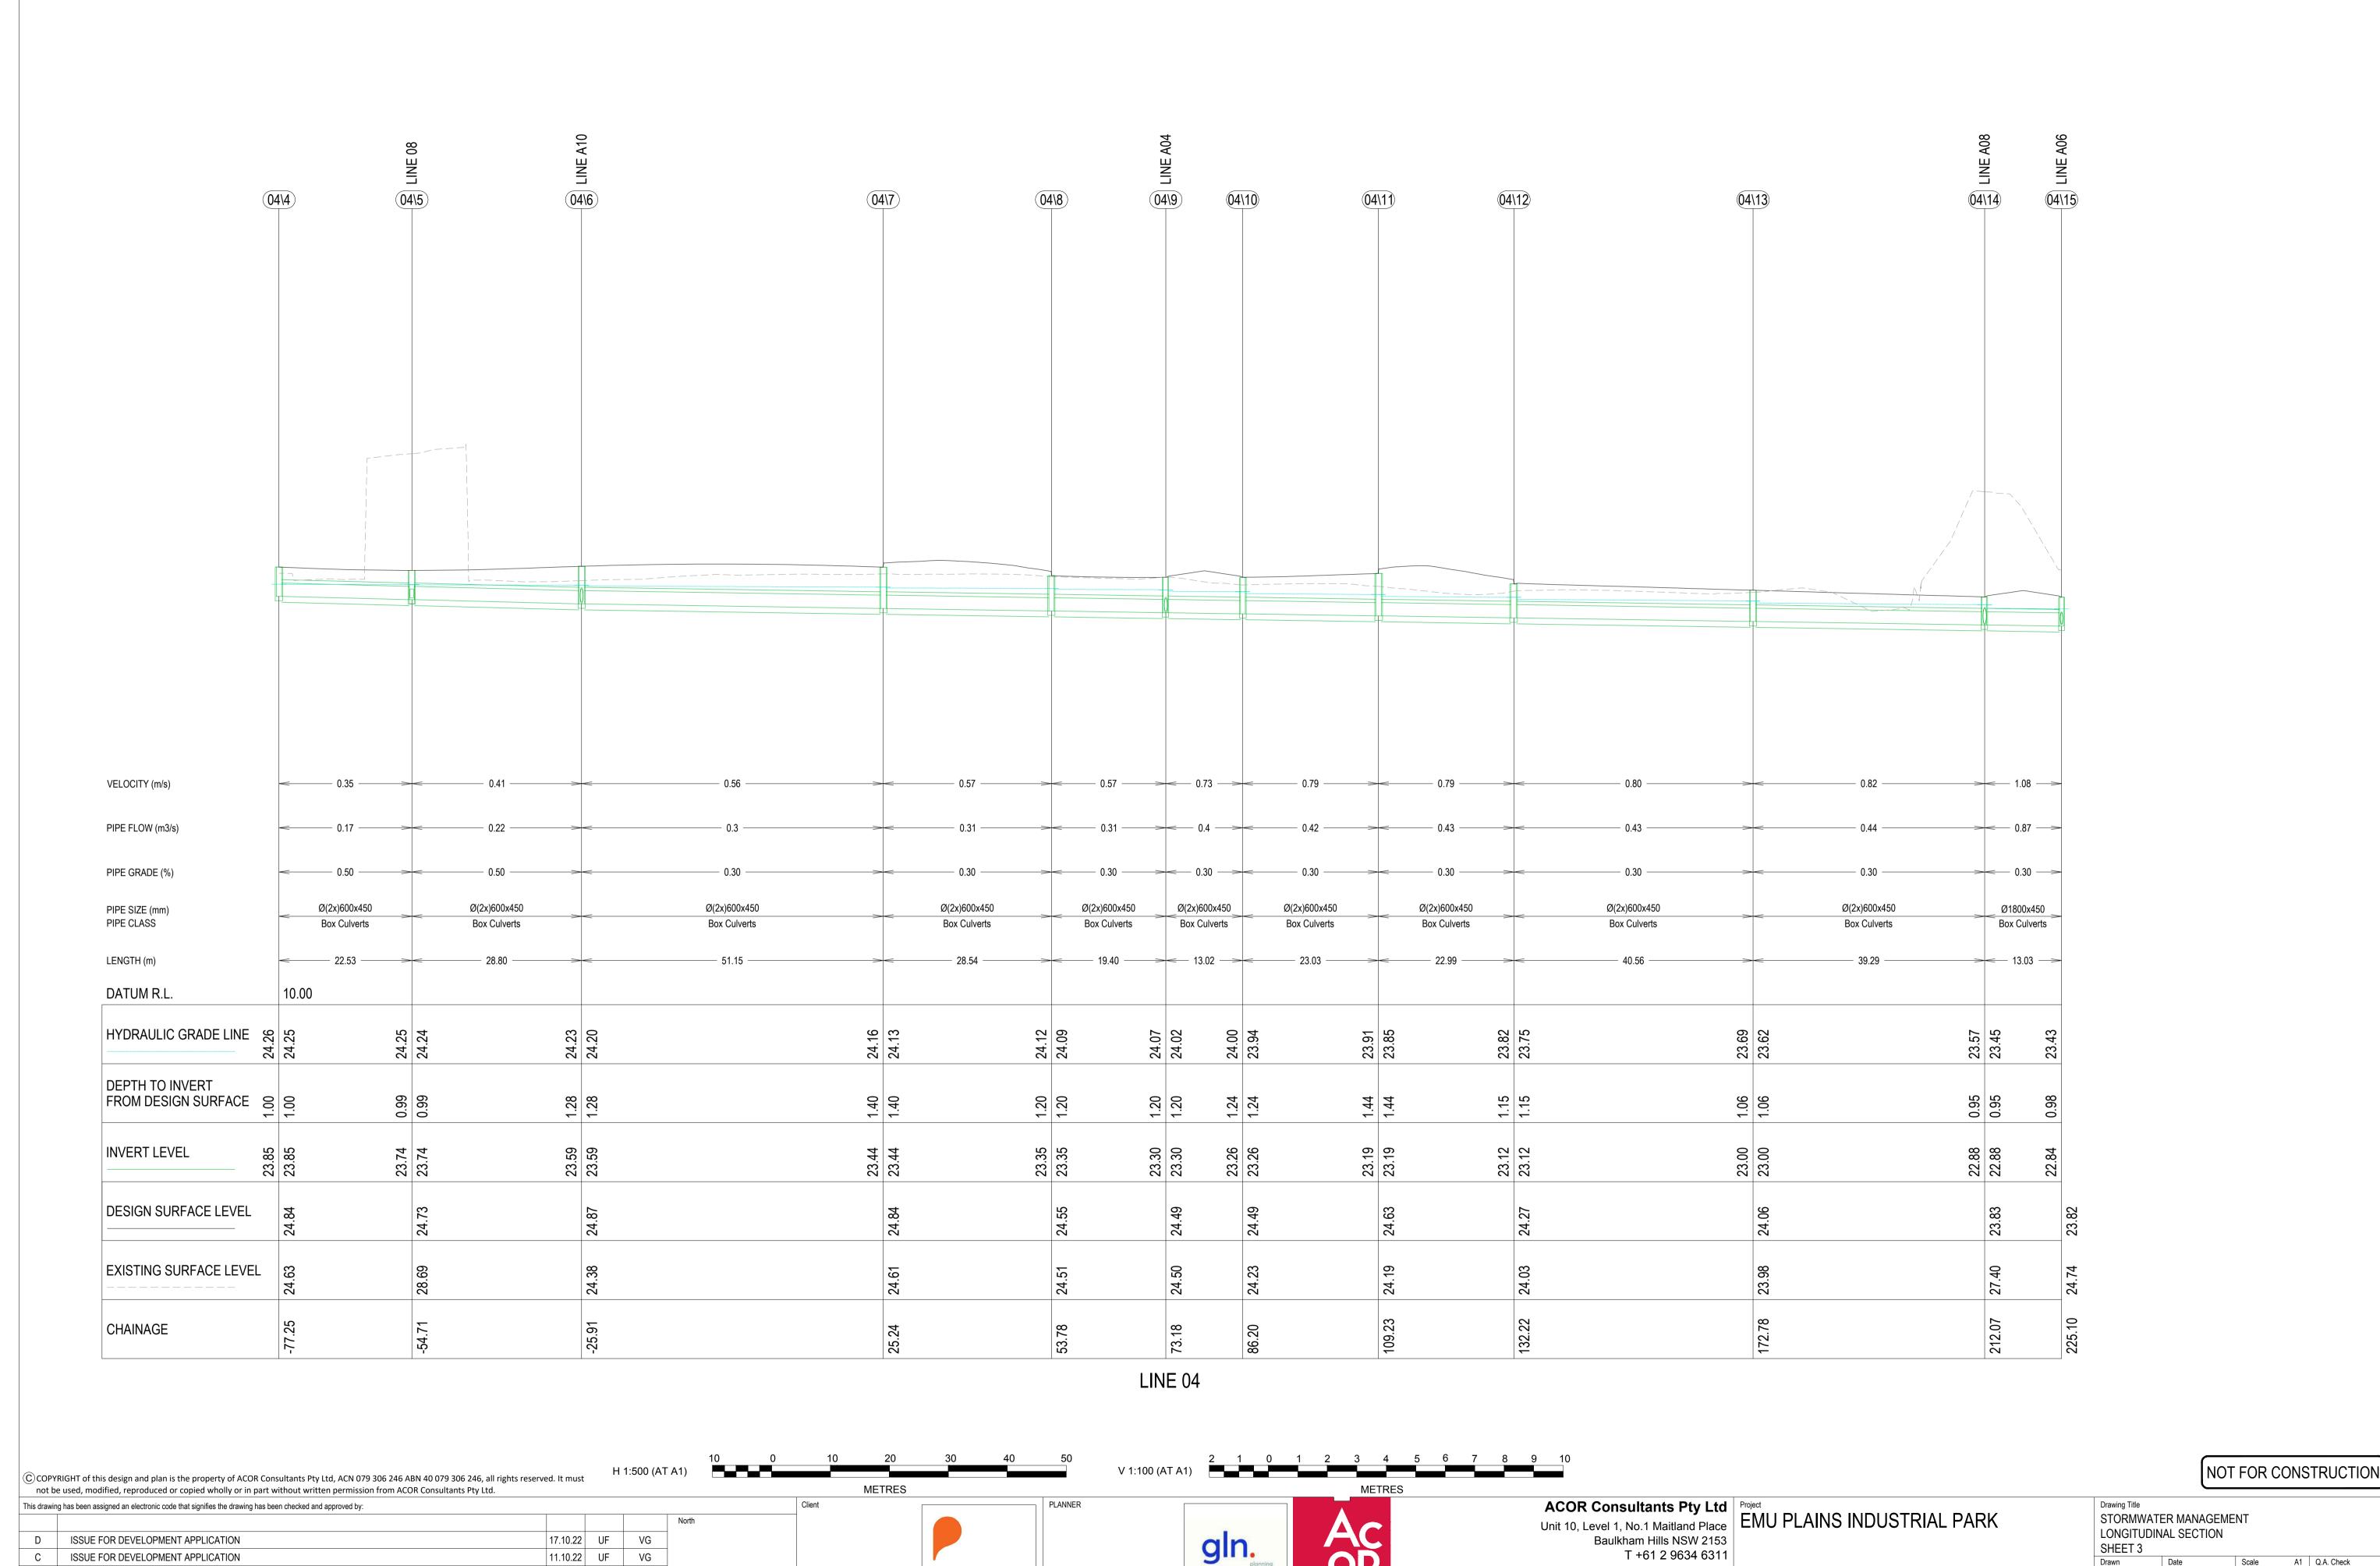
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158-164 OLD BATHURST ROAD EMU PLAINS, NSW 2750

SEP 2022 AS SHOWN UF Designed NSW211637 VG C7.401





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LEVEL 10, 70 PITT STREET SYDNEY, NSW 2000

PHONE: (02) 9249 4100

Baulkham Hills NSW 2153

CONSULTANTS ENGINEERS | MANAGERS | INFRASTRUCTURE PLANNERS | DEVELOPMENT CONSULTANTS

T +61 2 9634 6311

158-164 OLD BATHURST ROAD EMU PLAINS, NSW 2750

SHEET 3

UF

VG

Designed

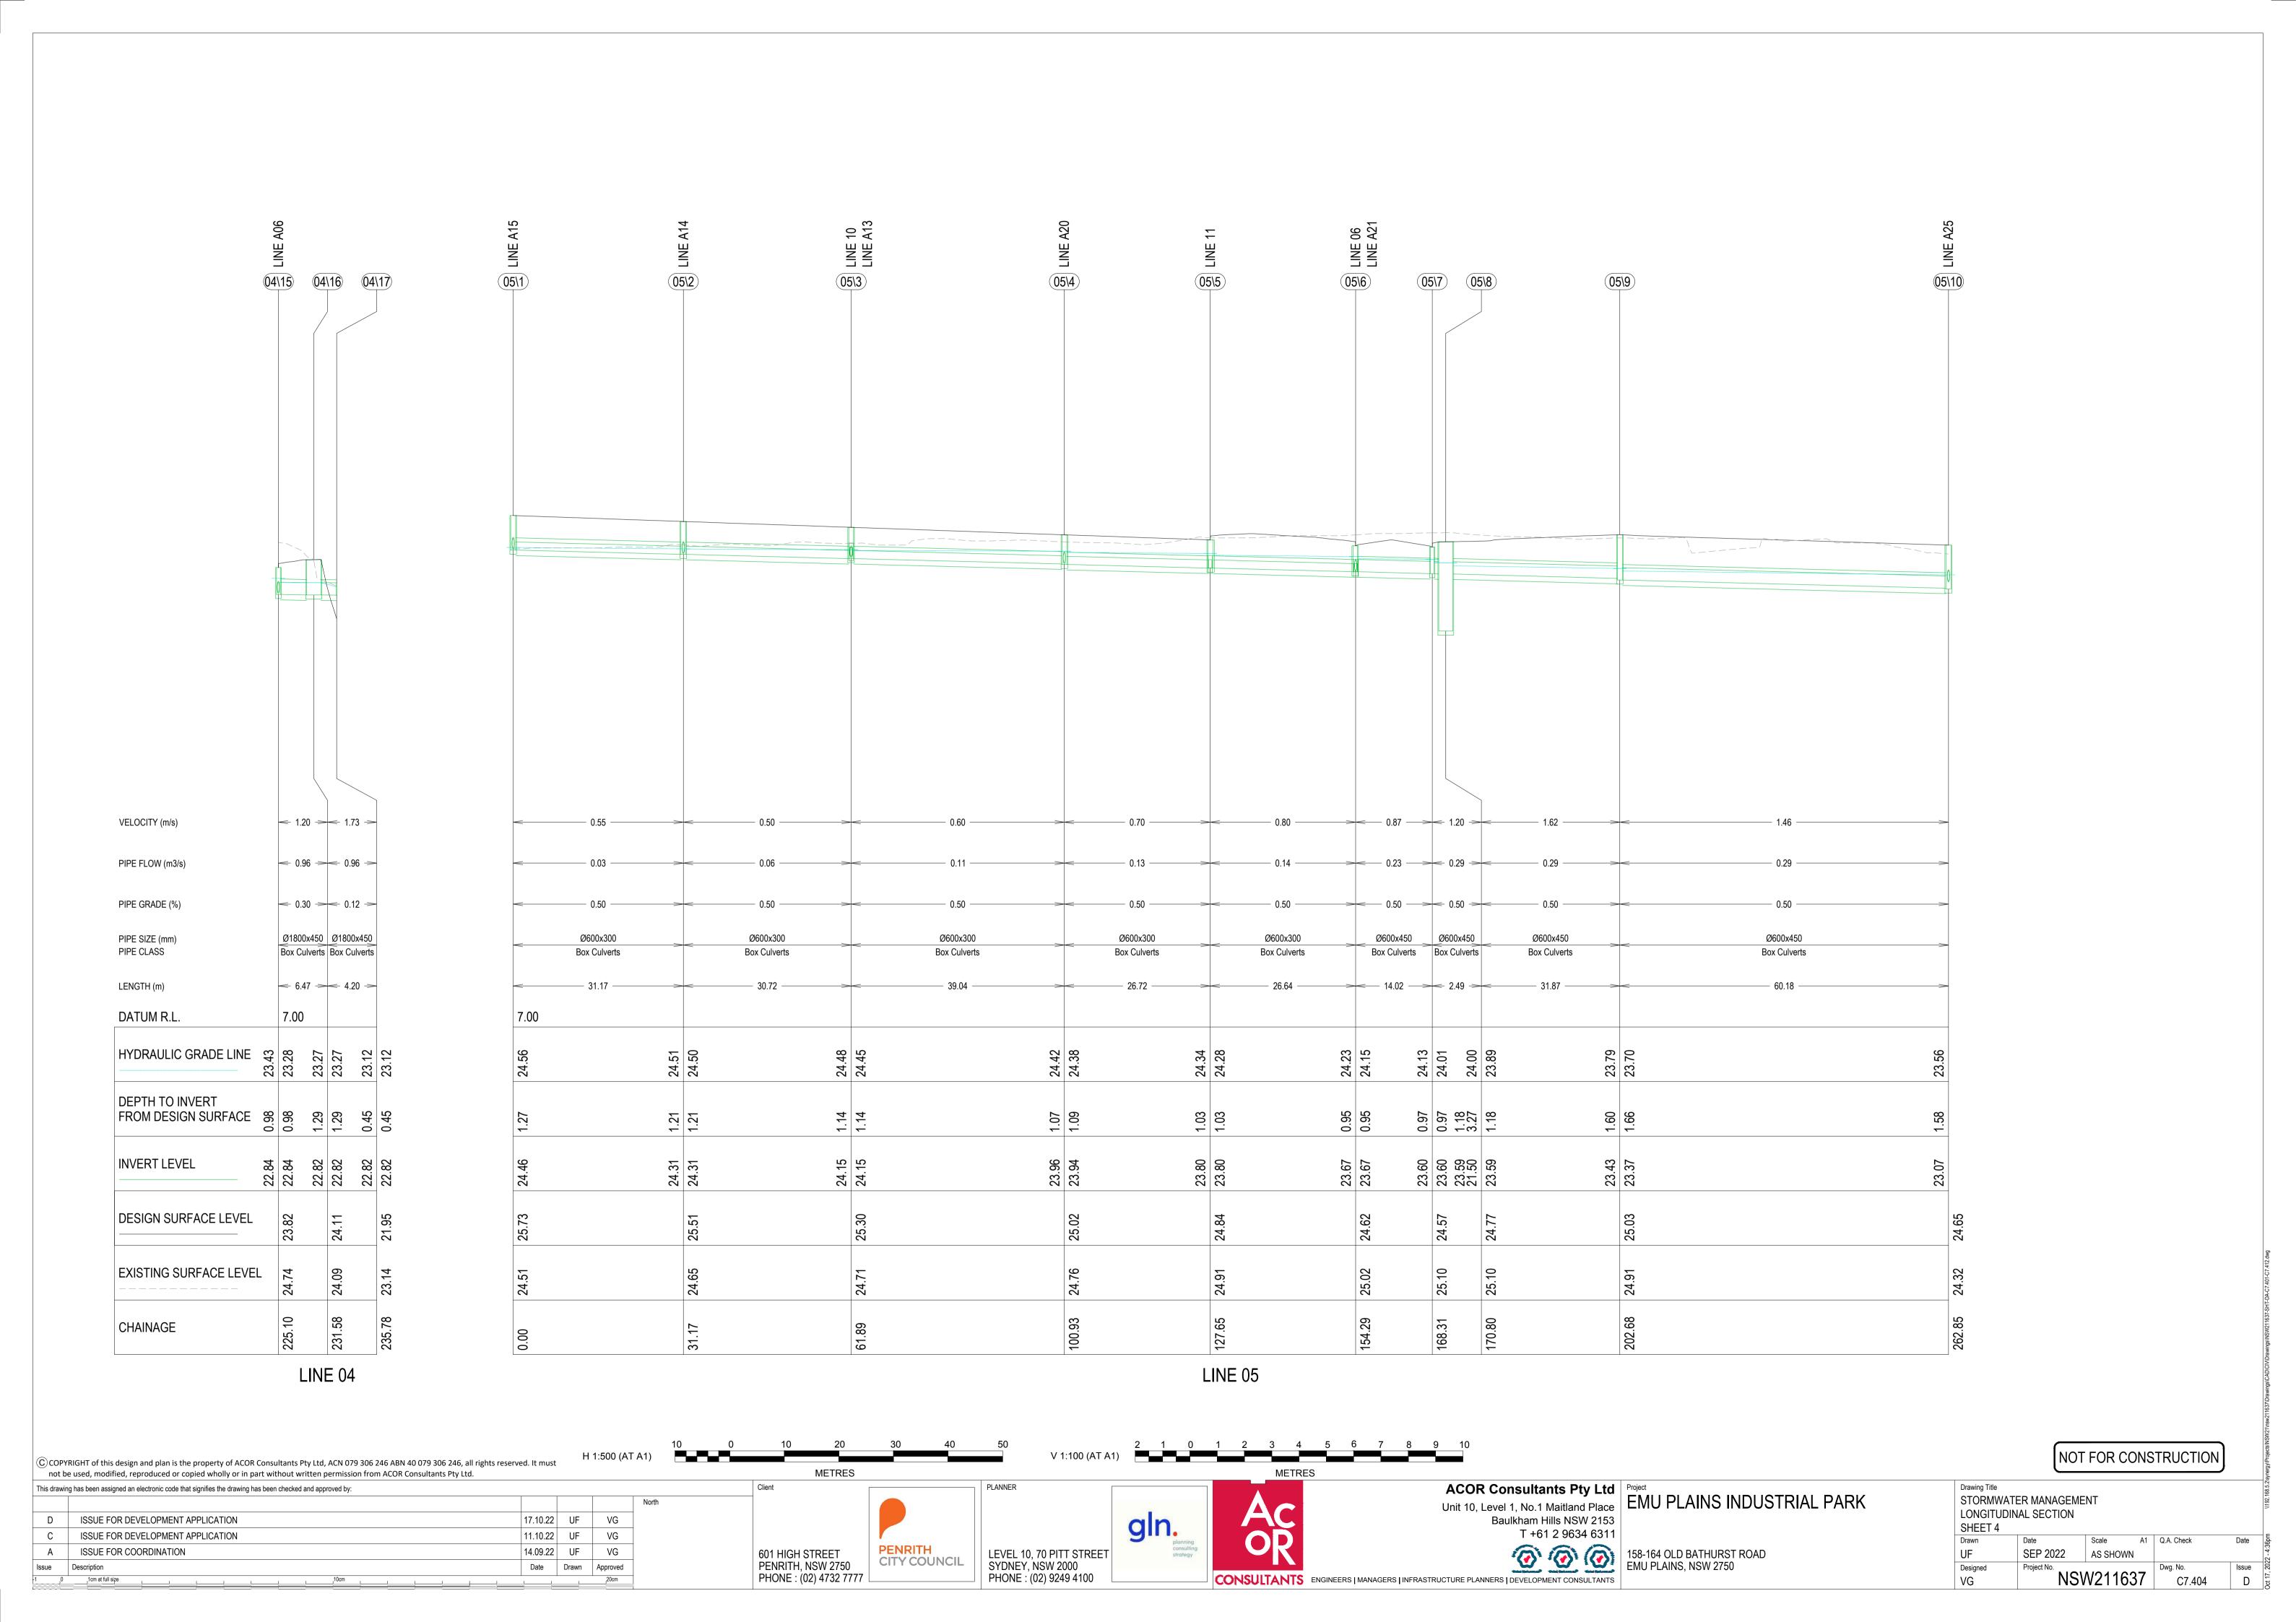
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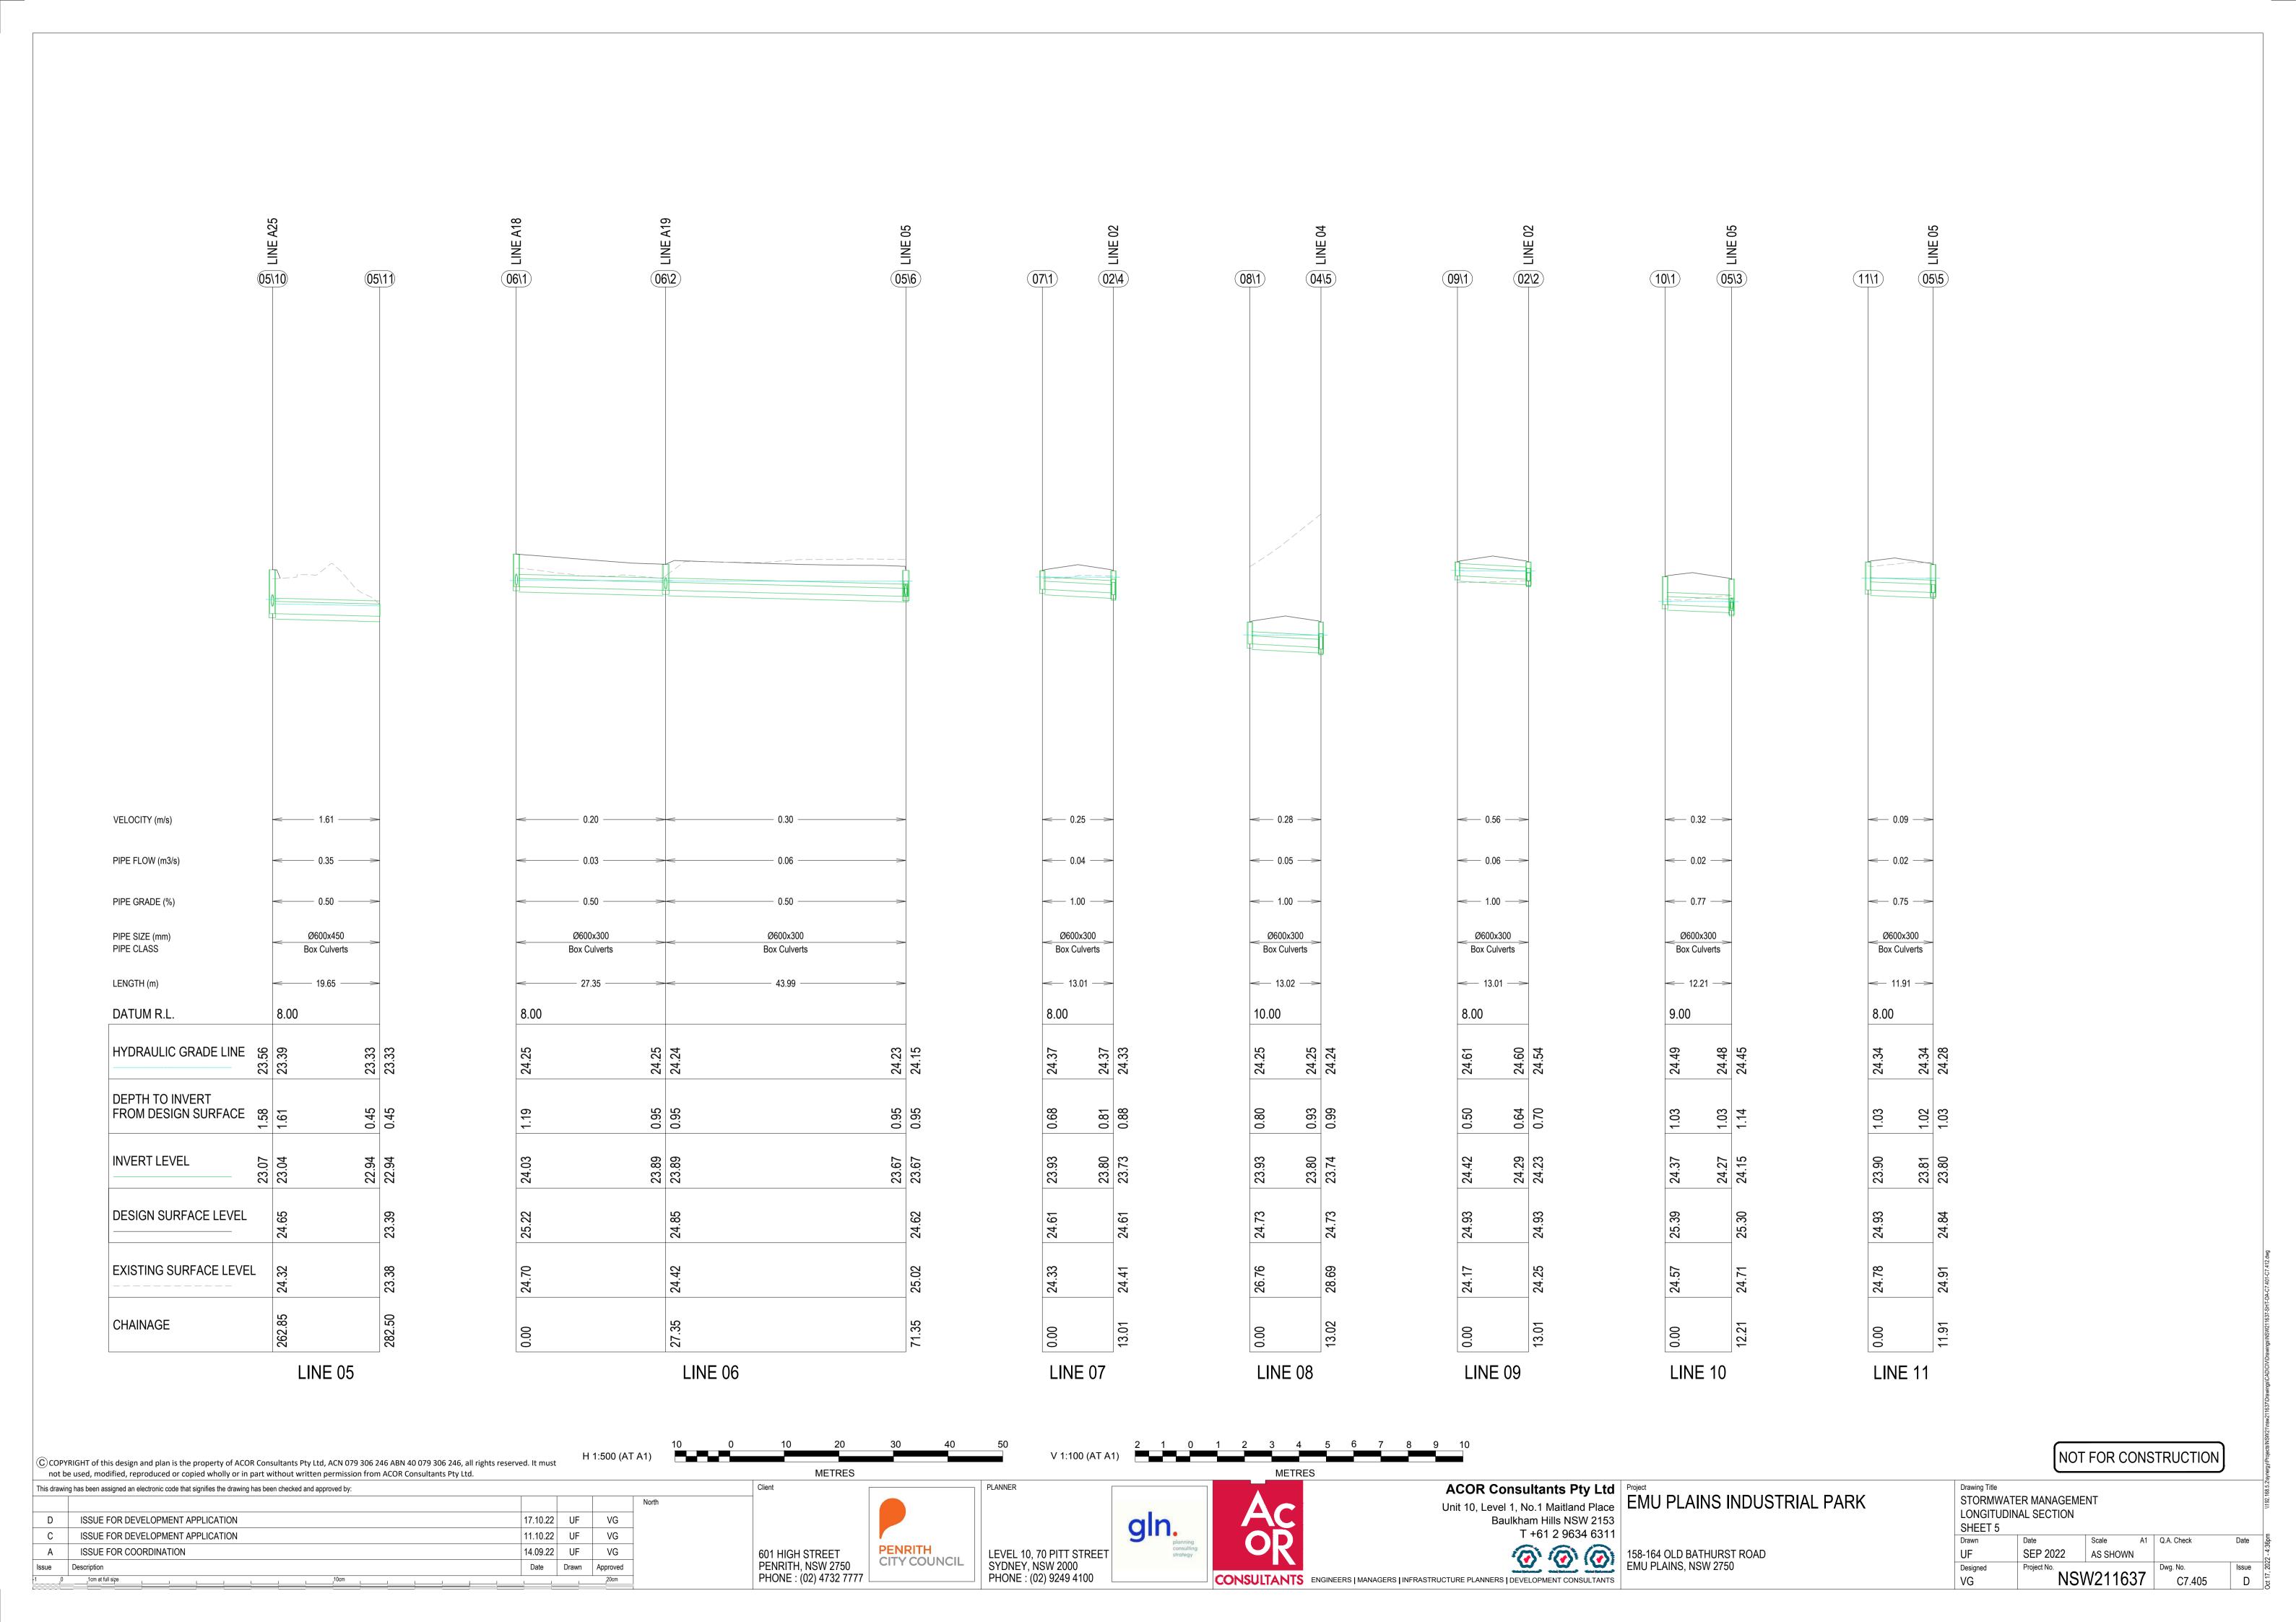
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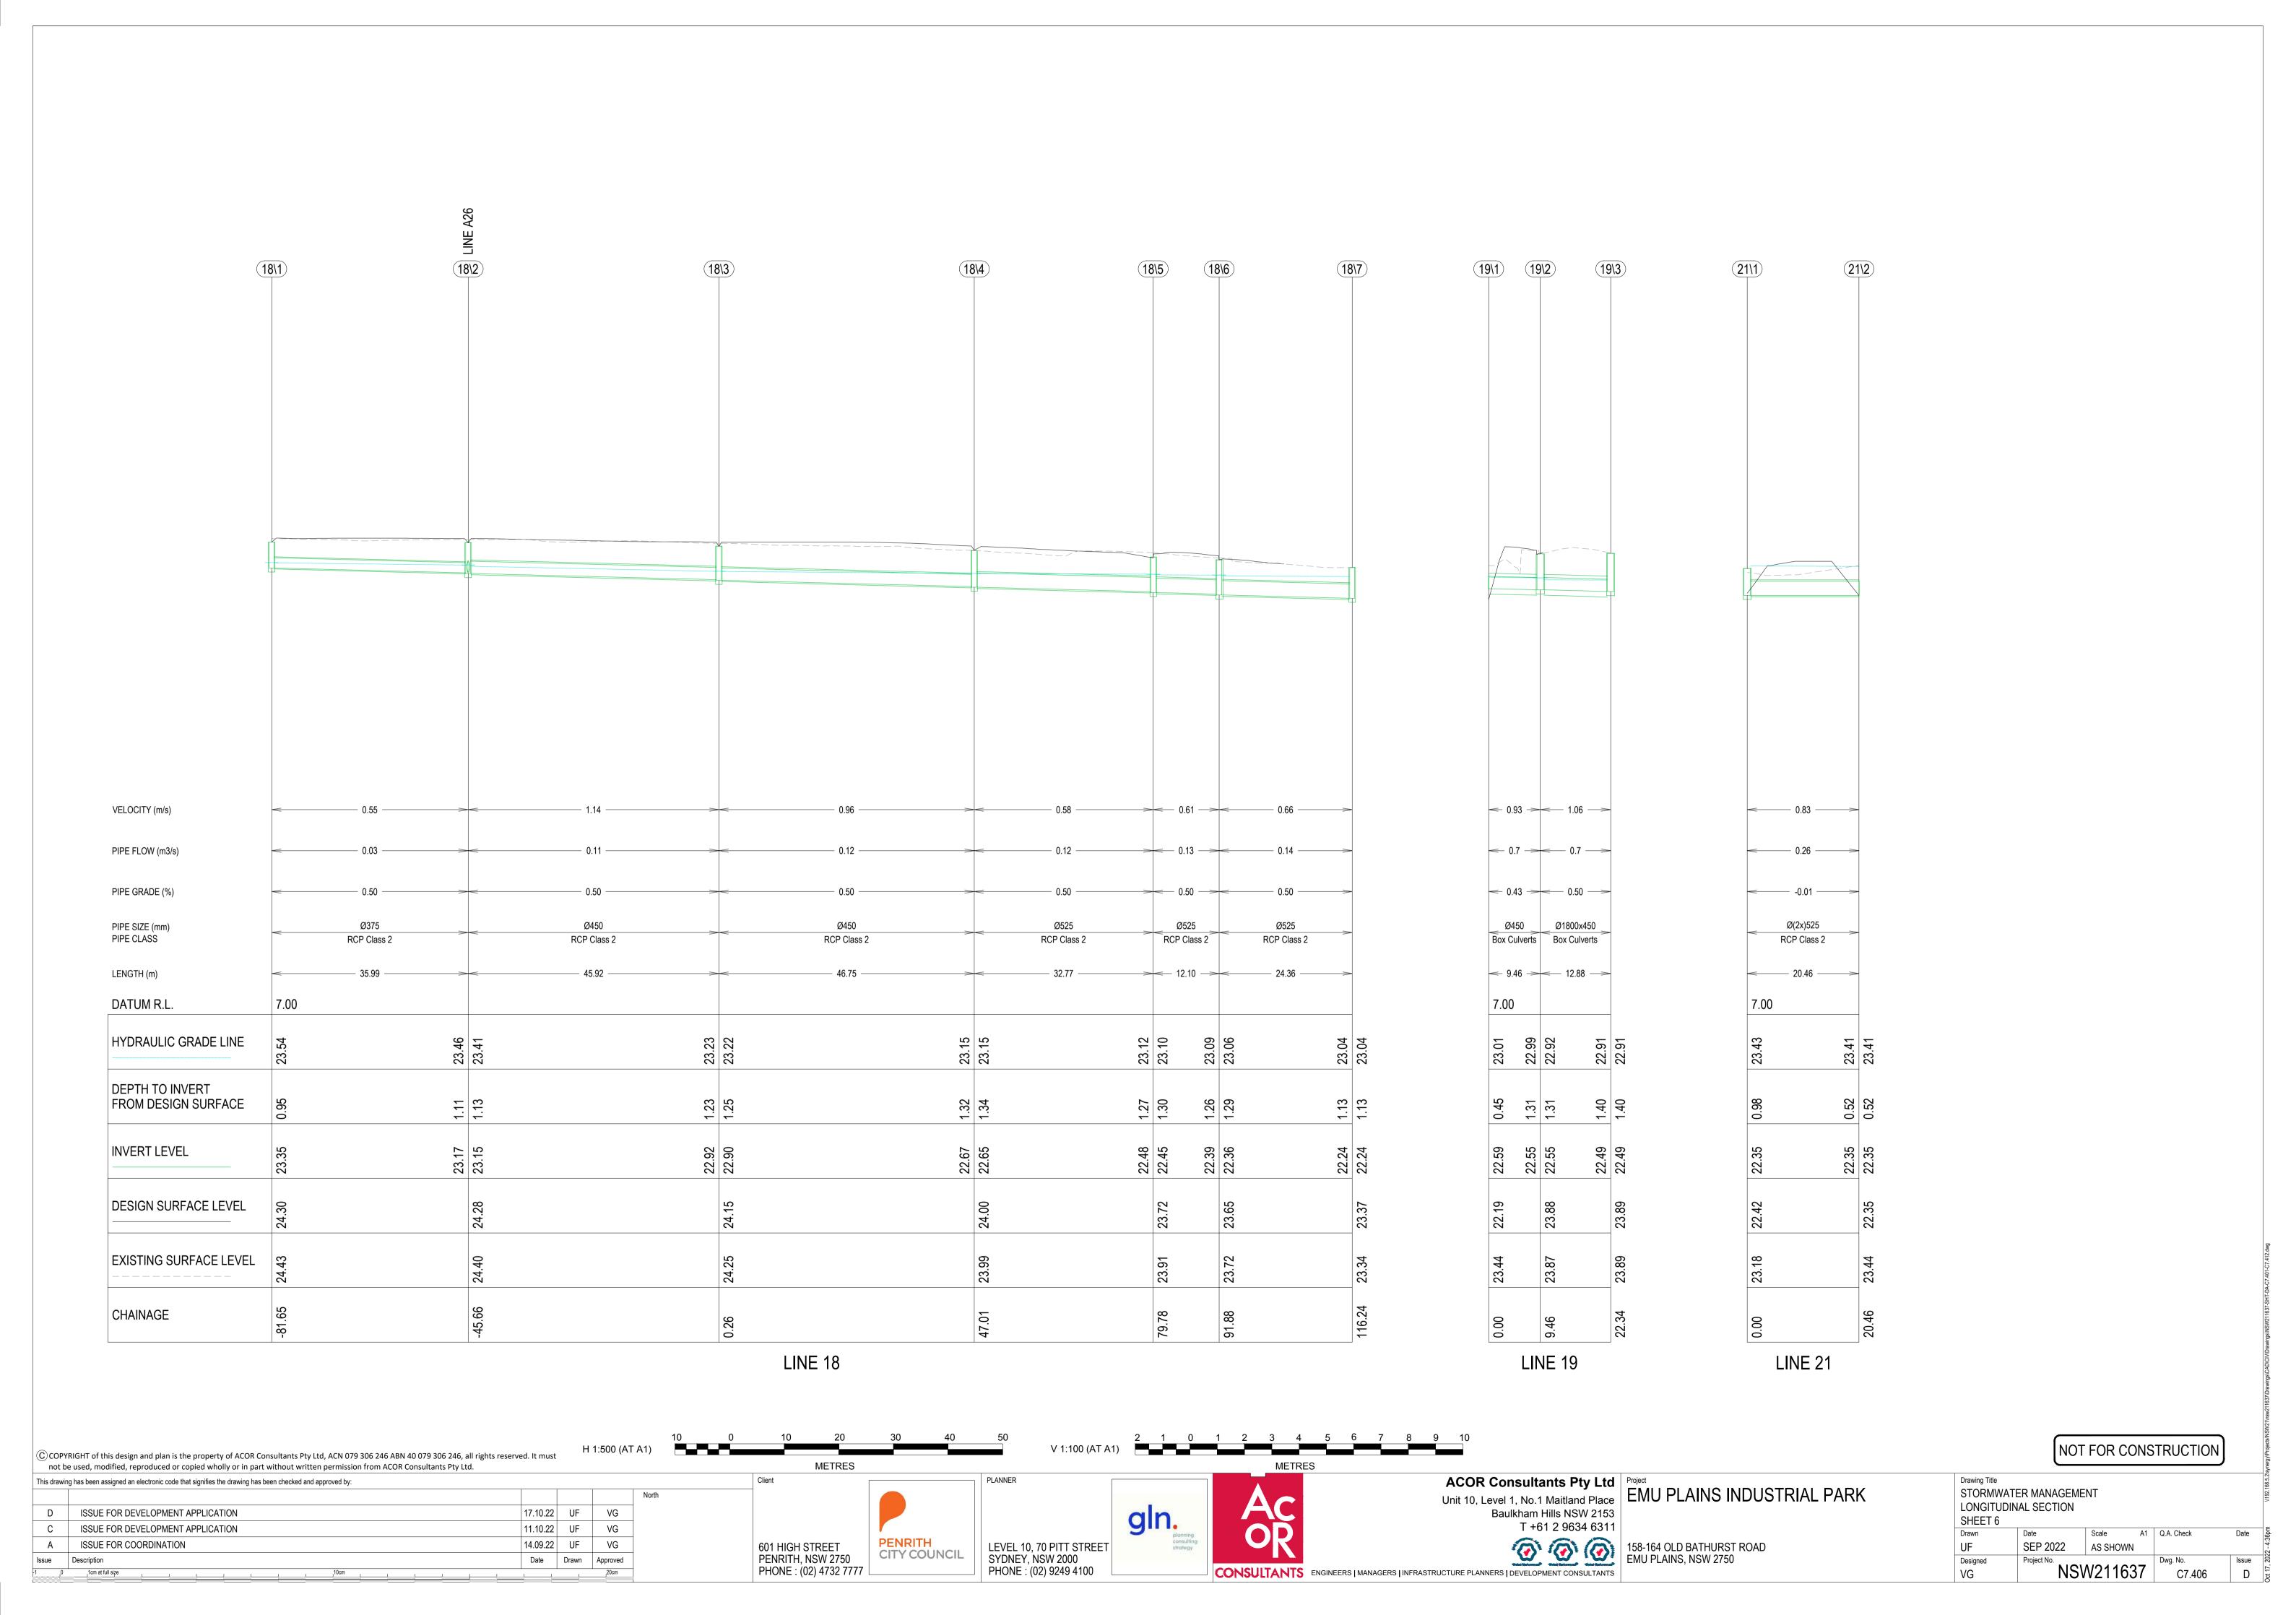
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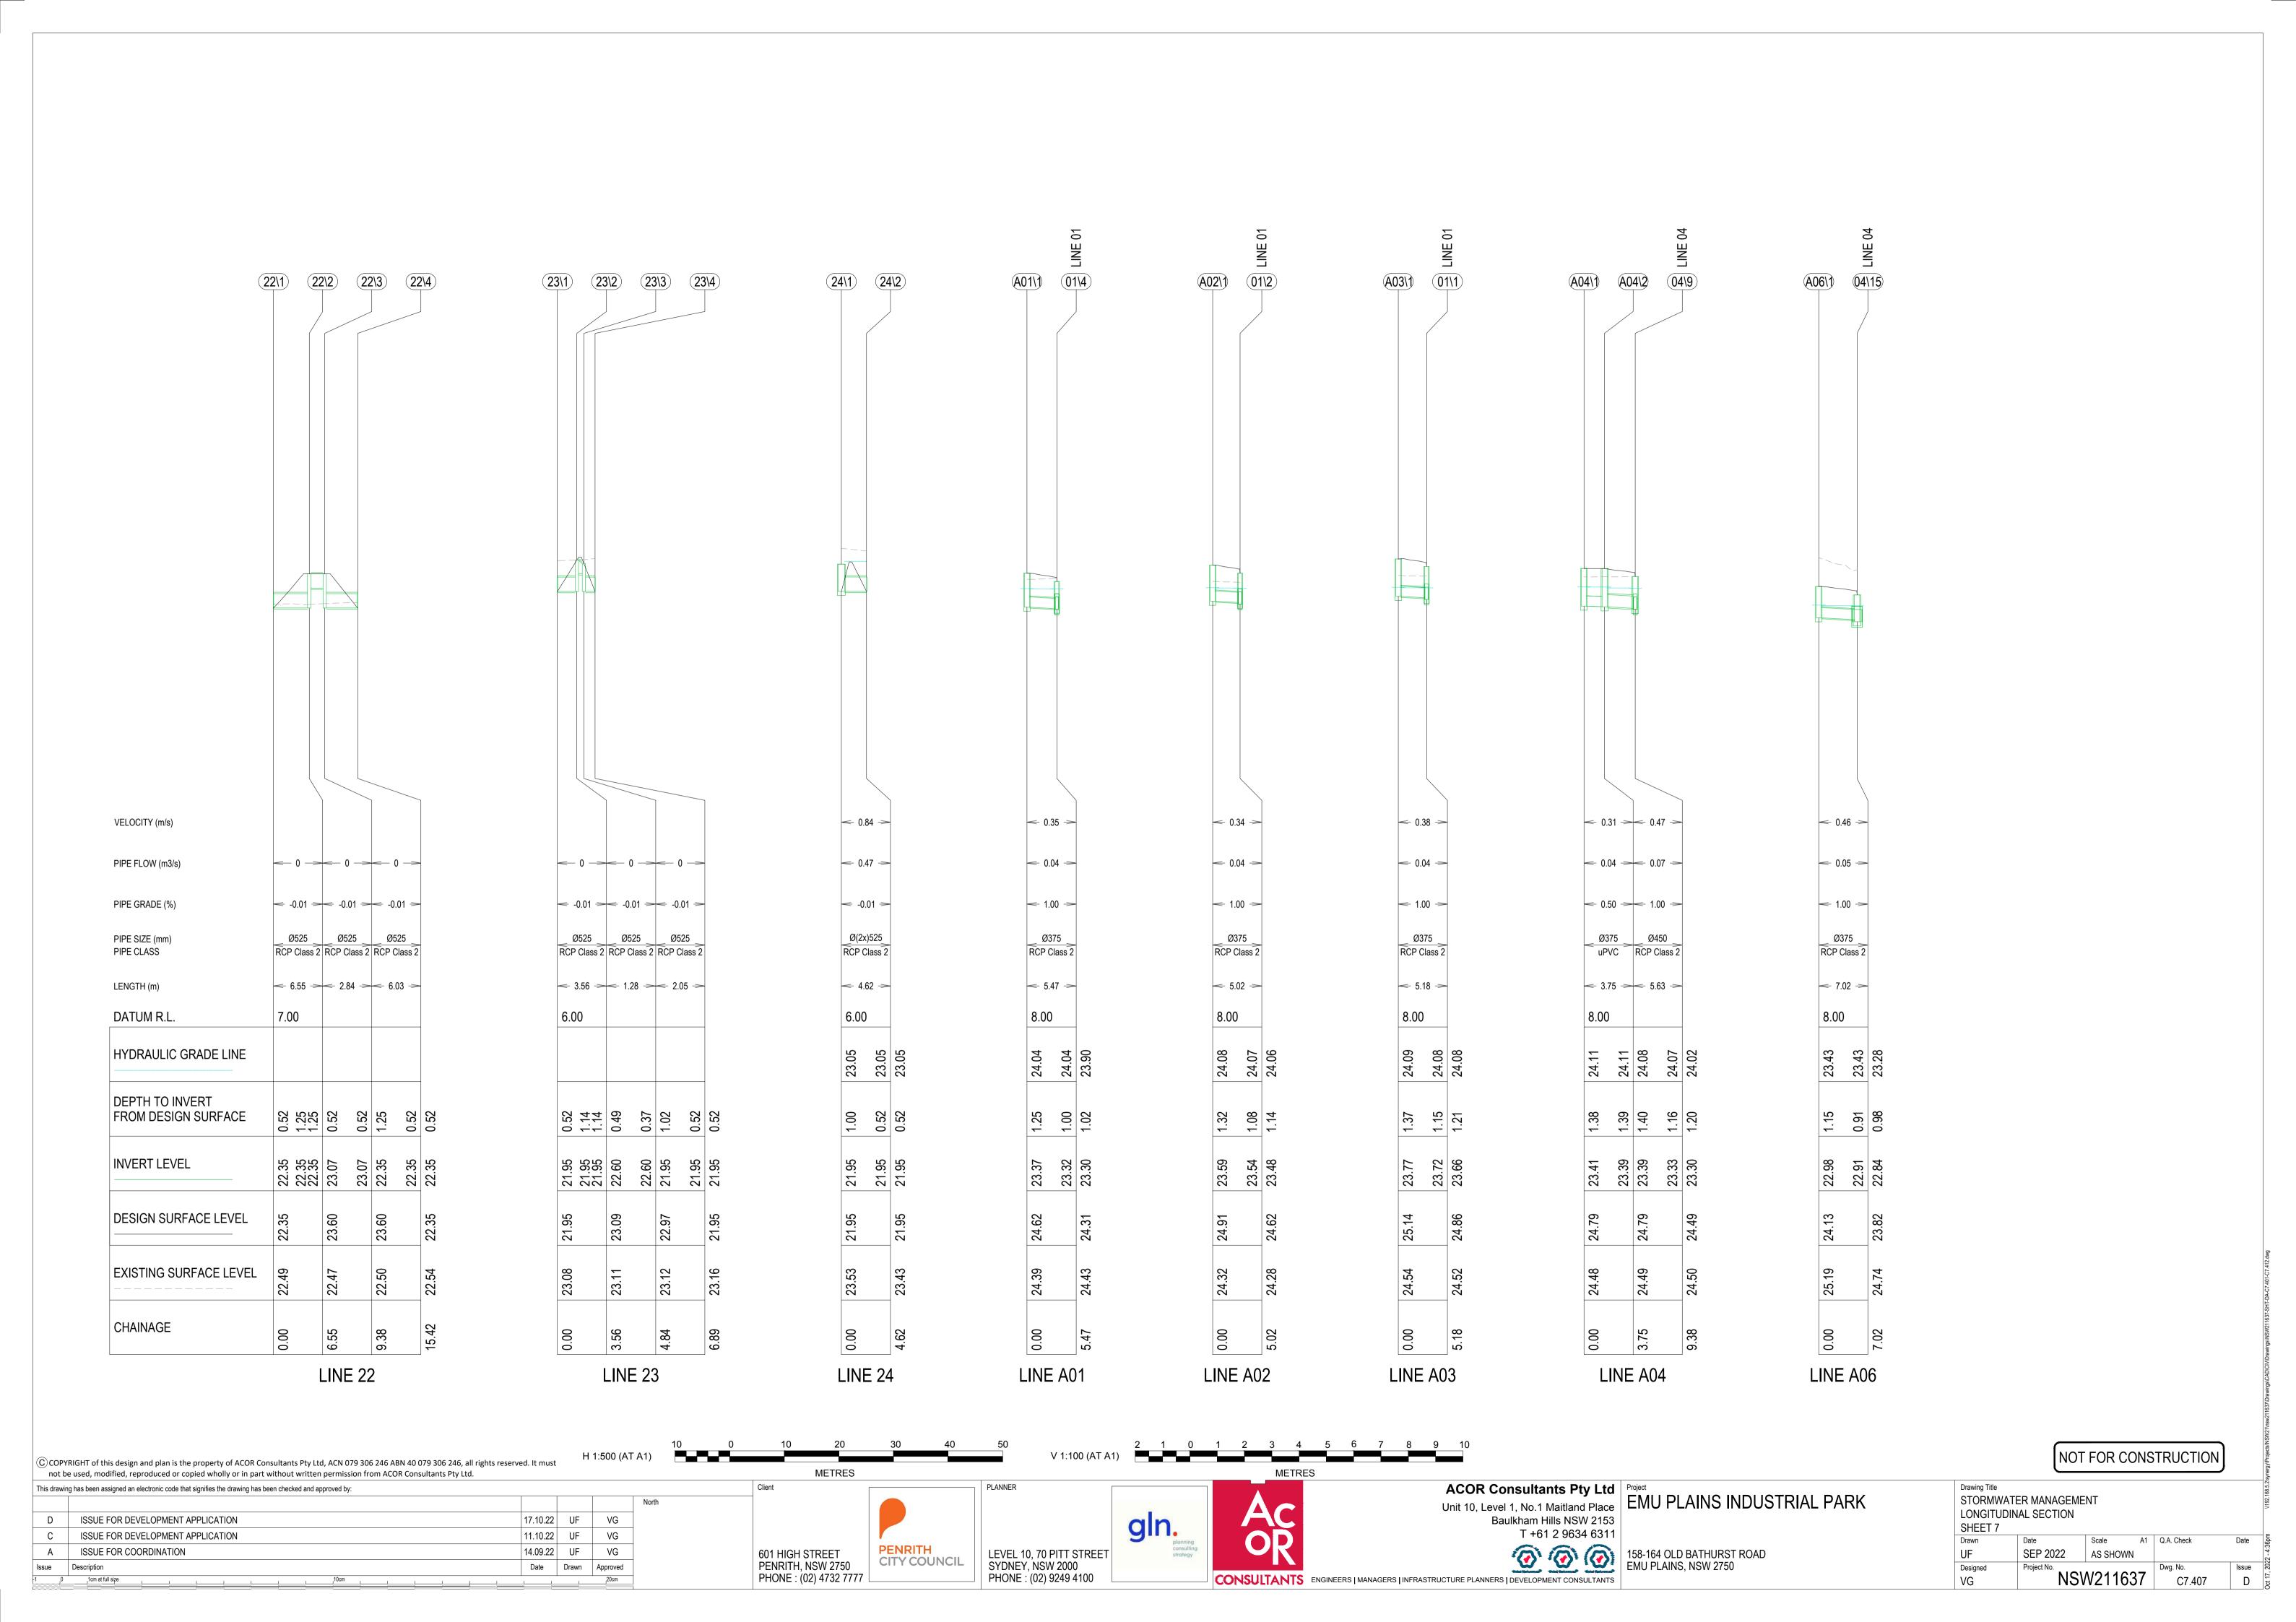
NSW211637


SEP 2022 AS SHOWN












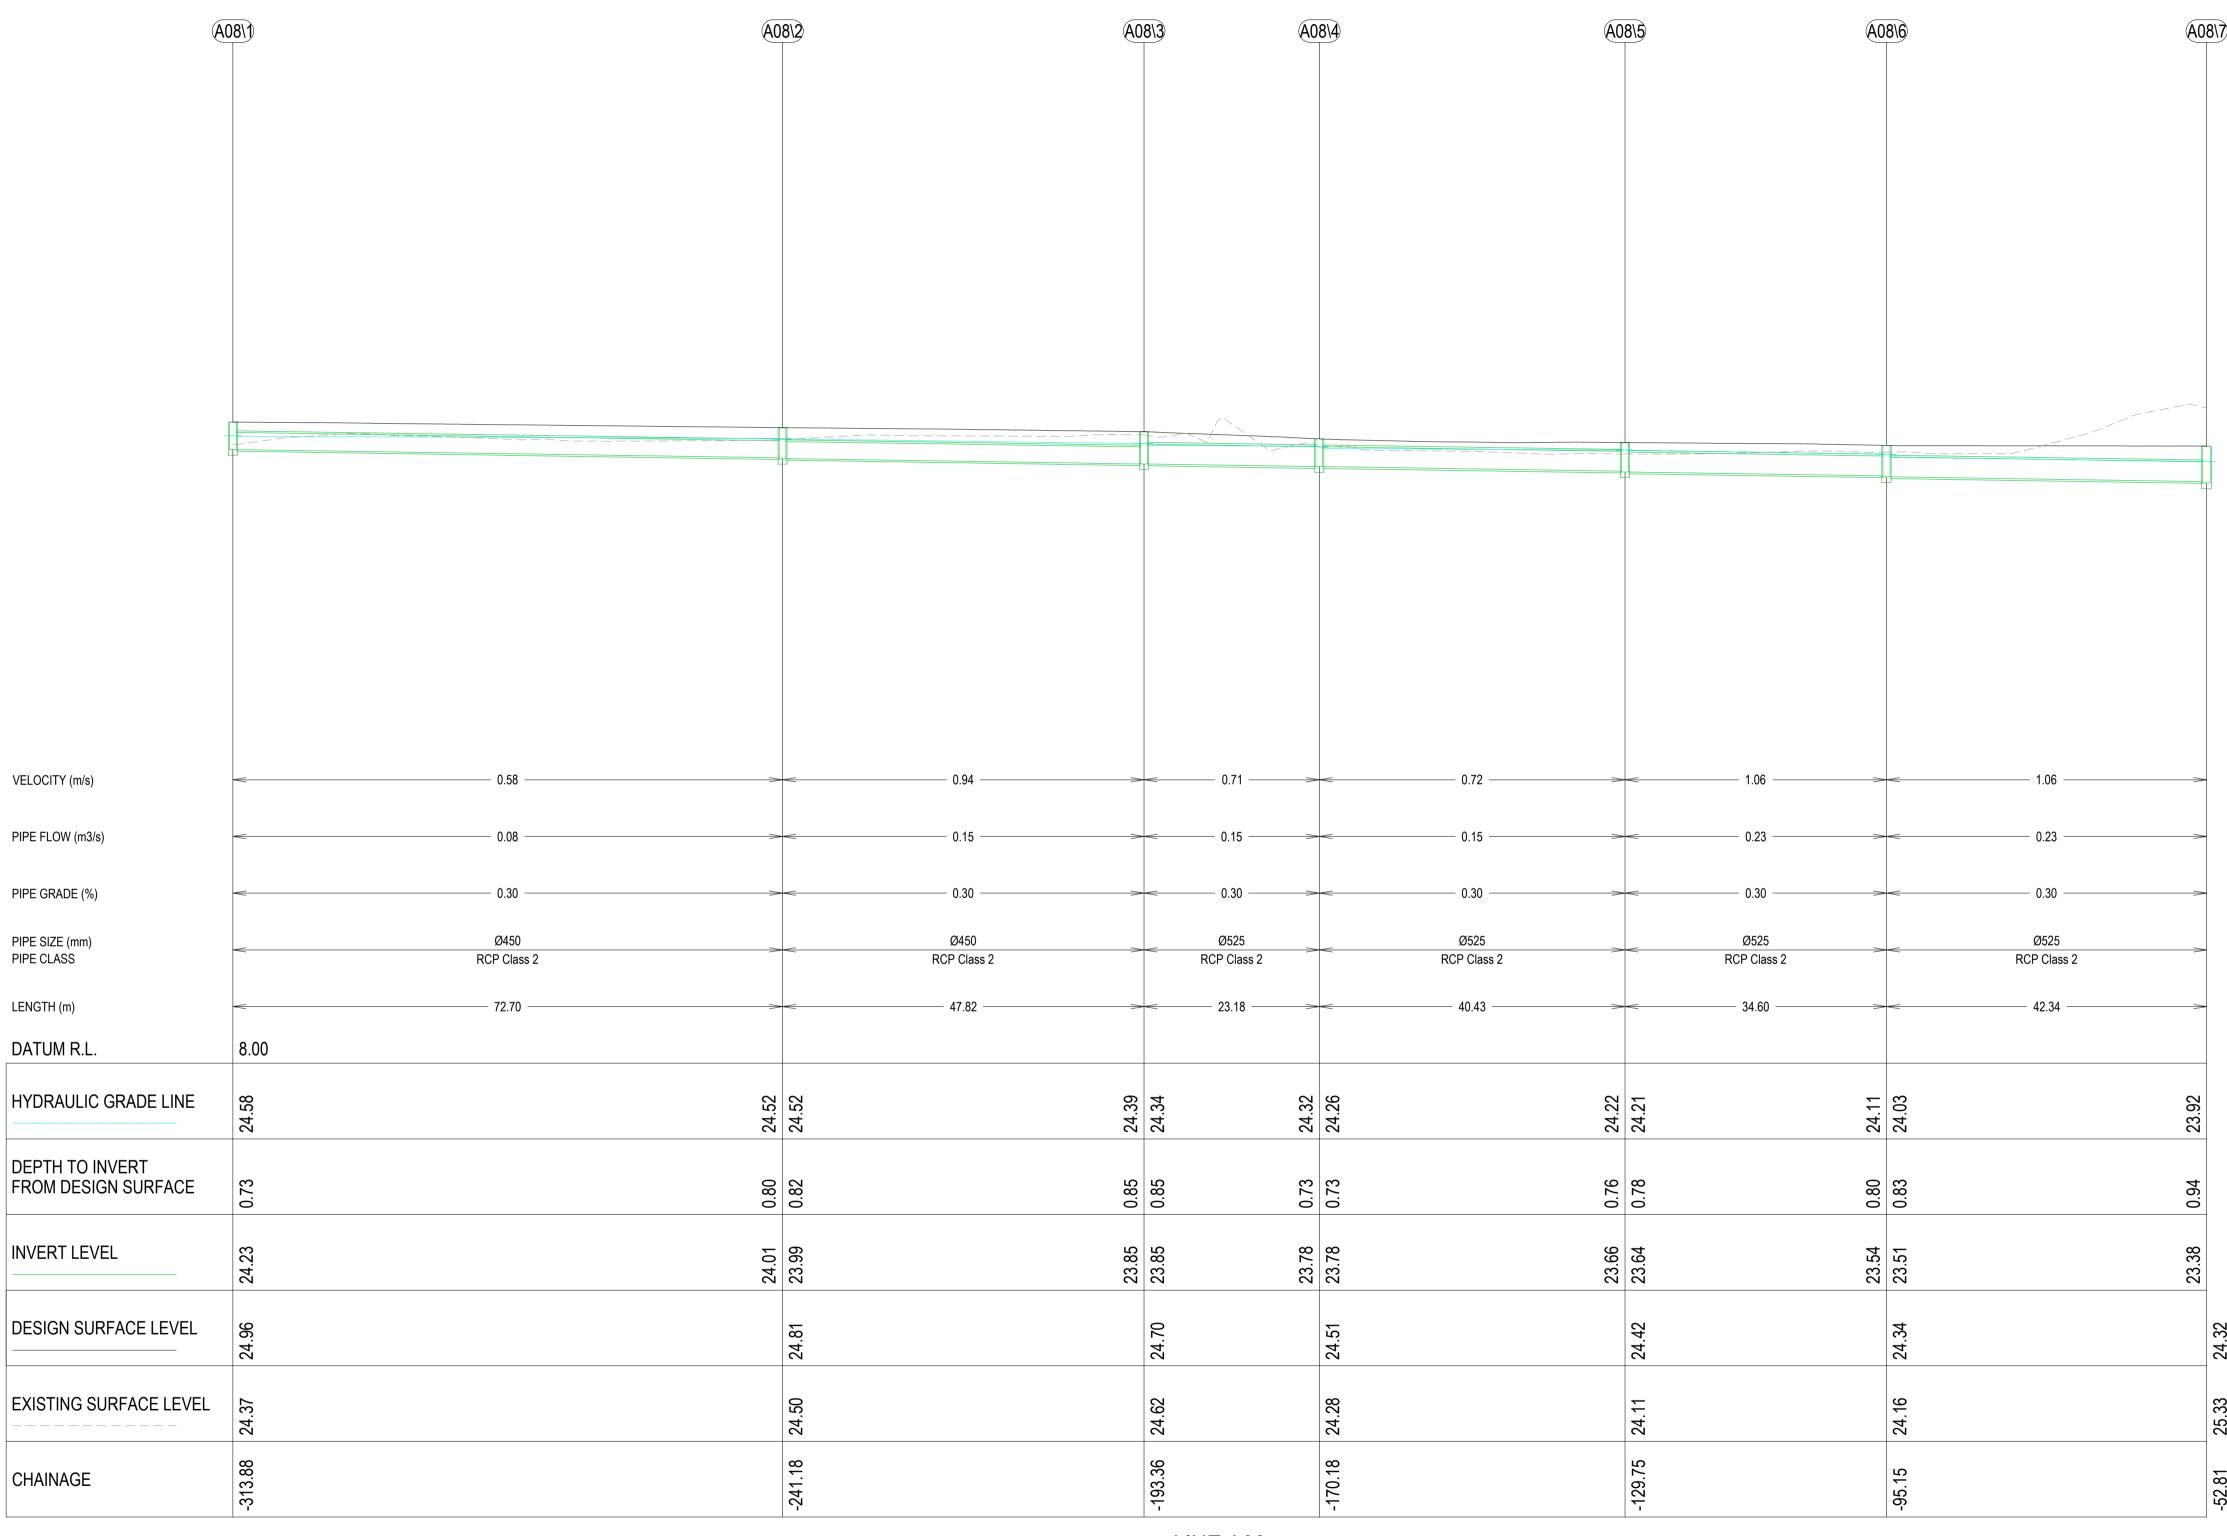



LINE A08

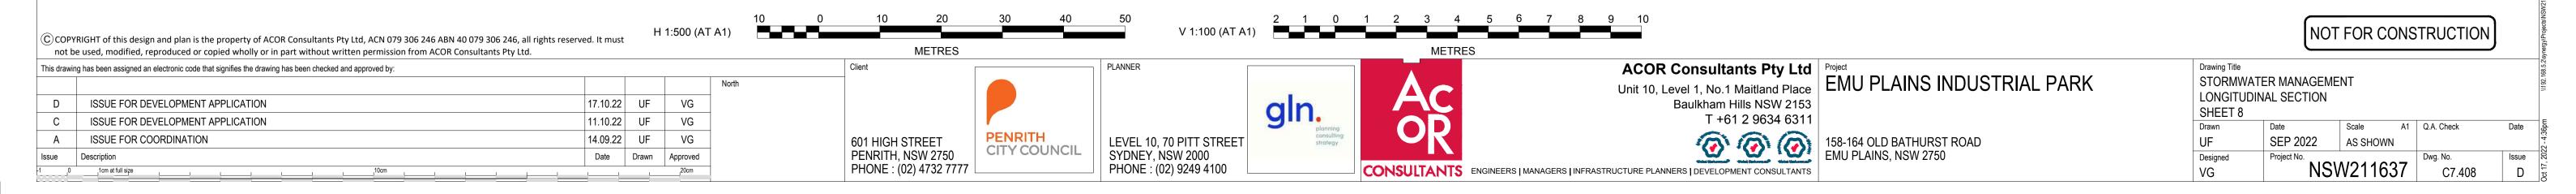


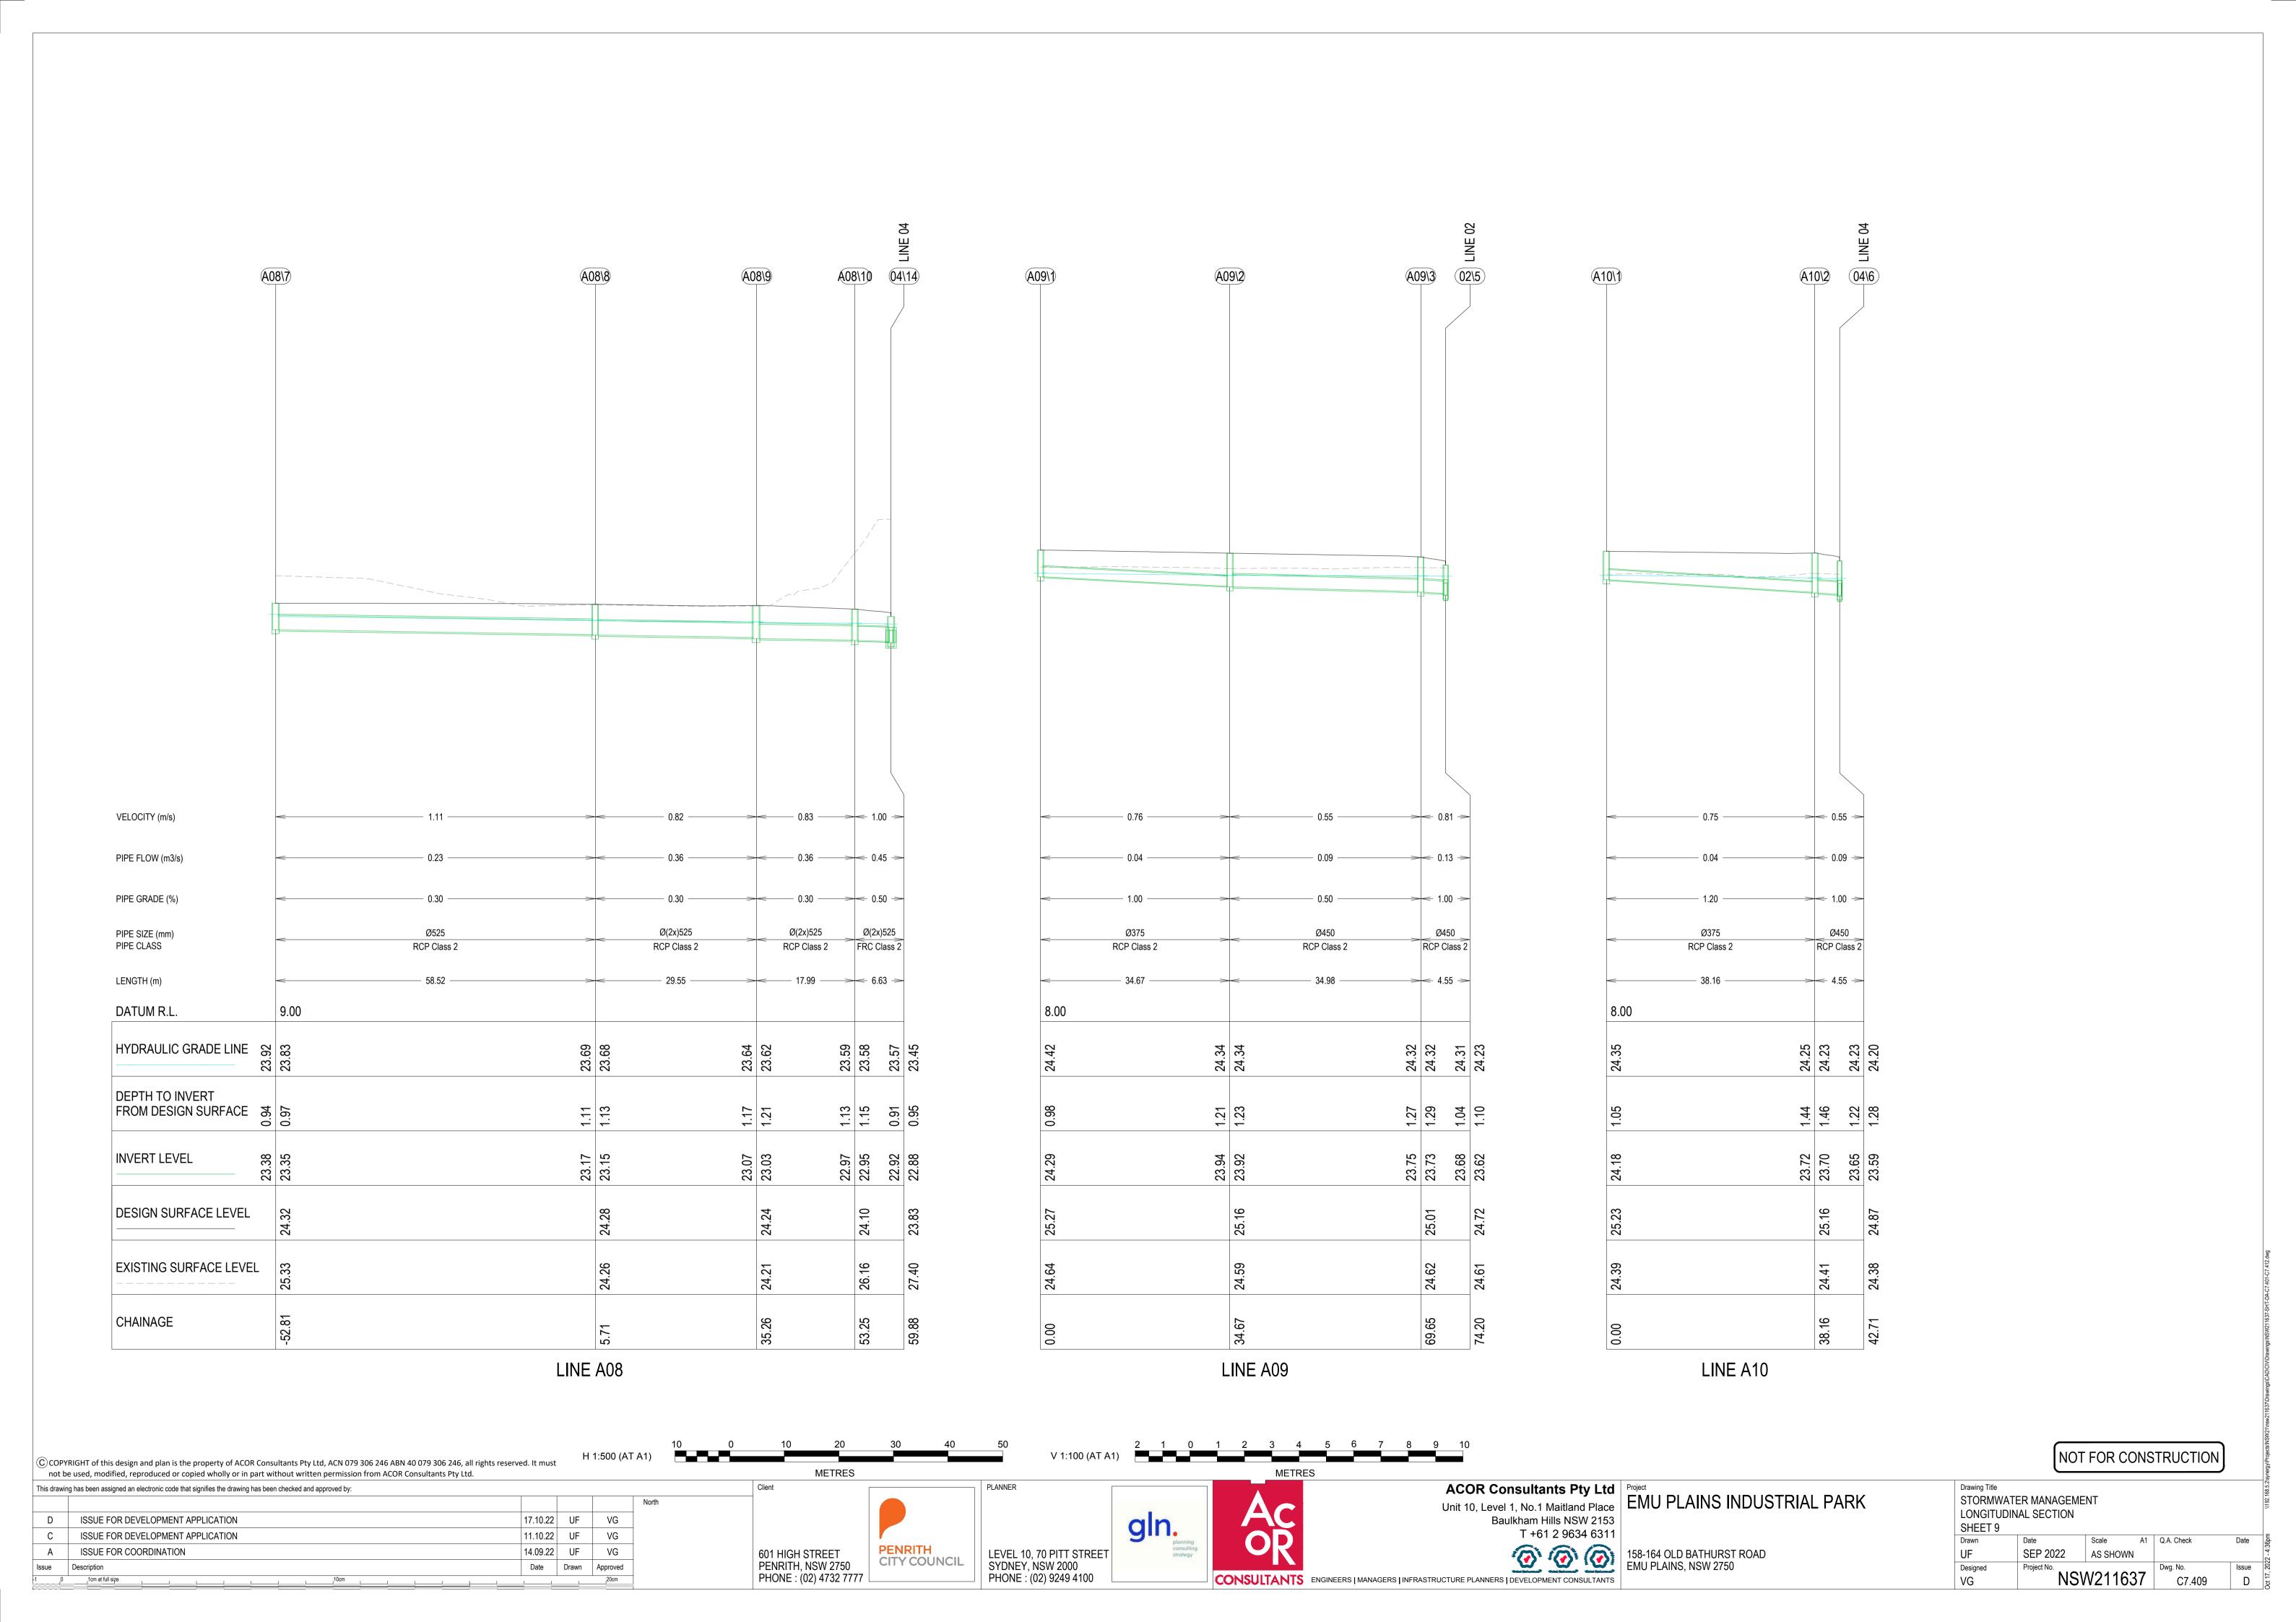

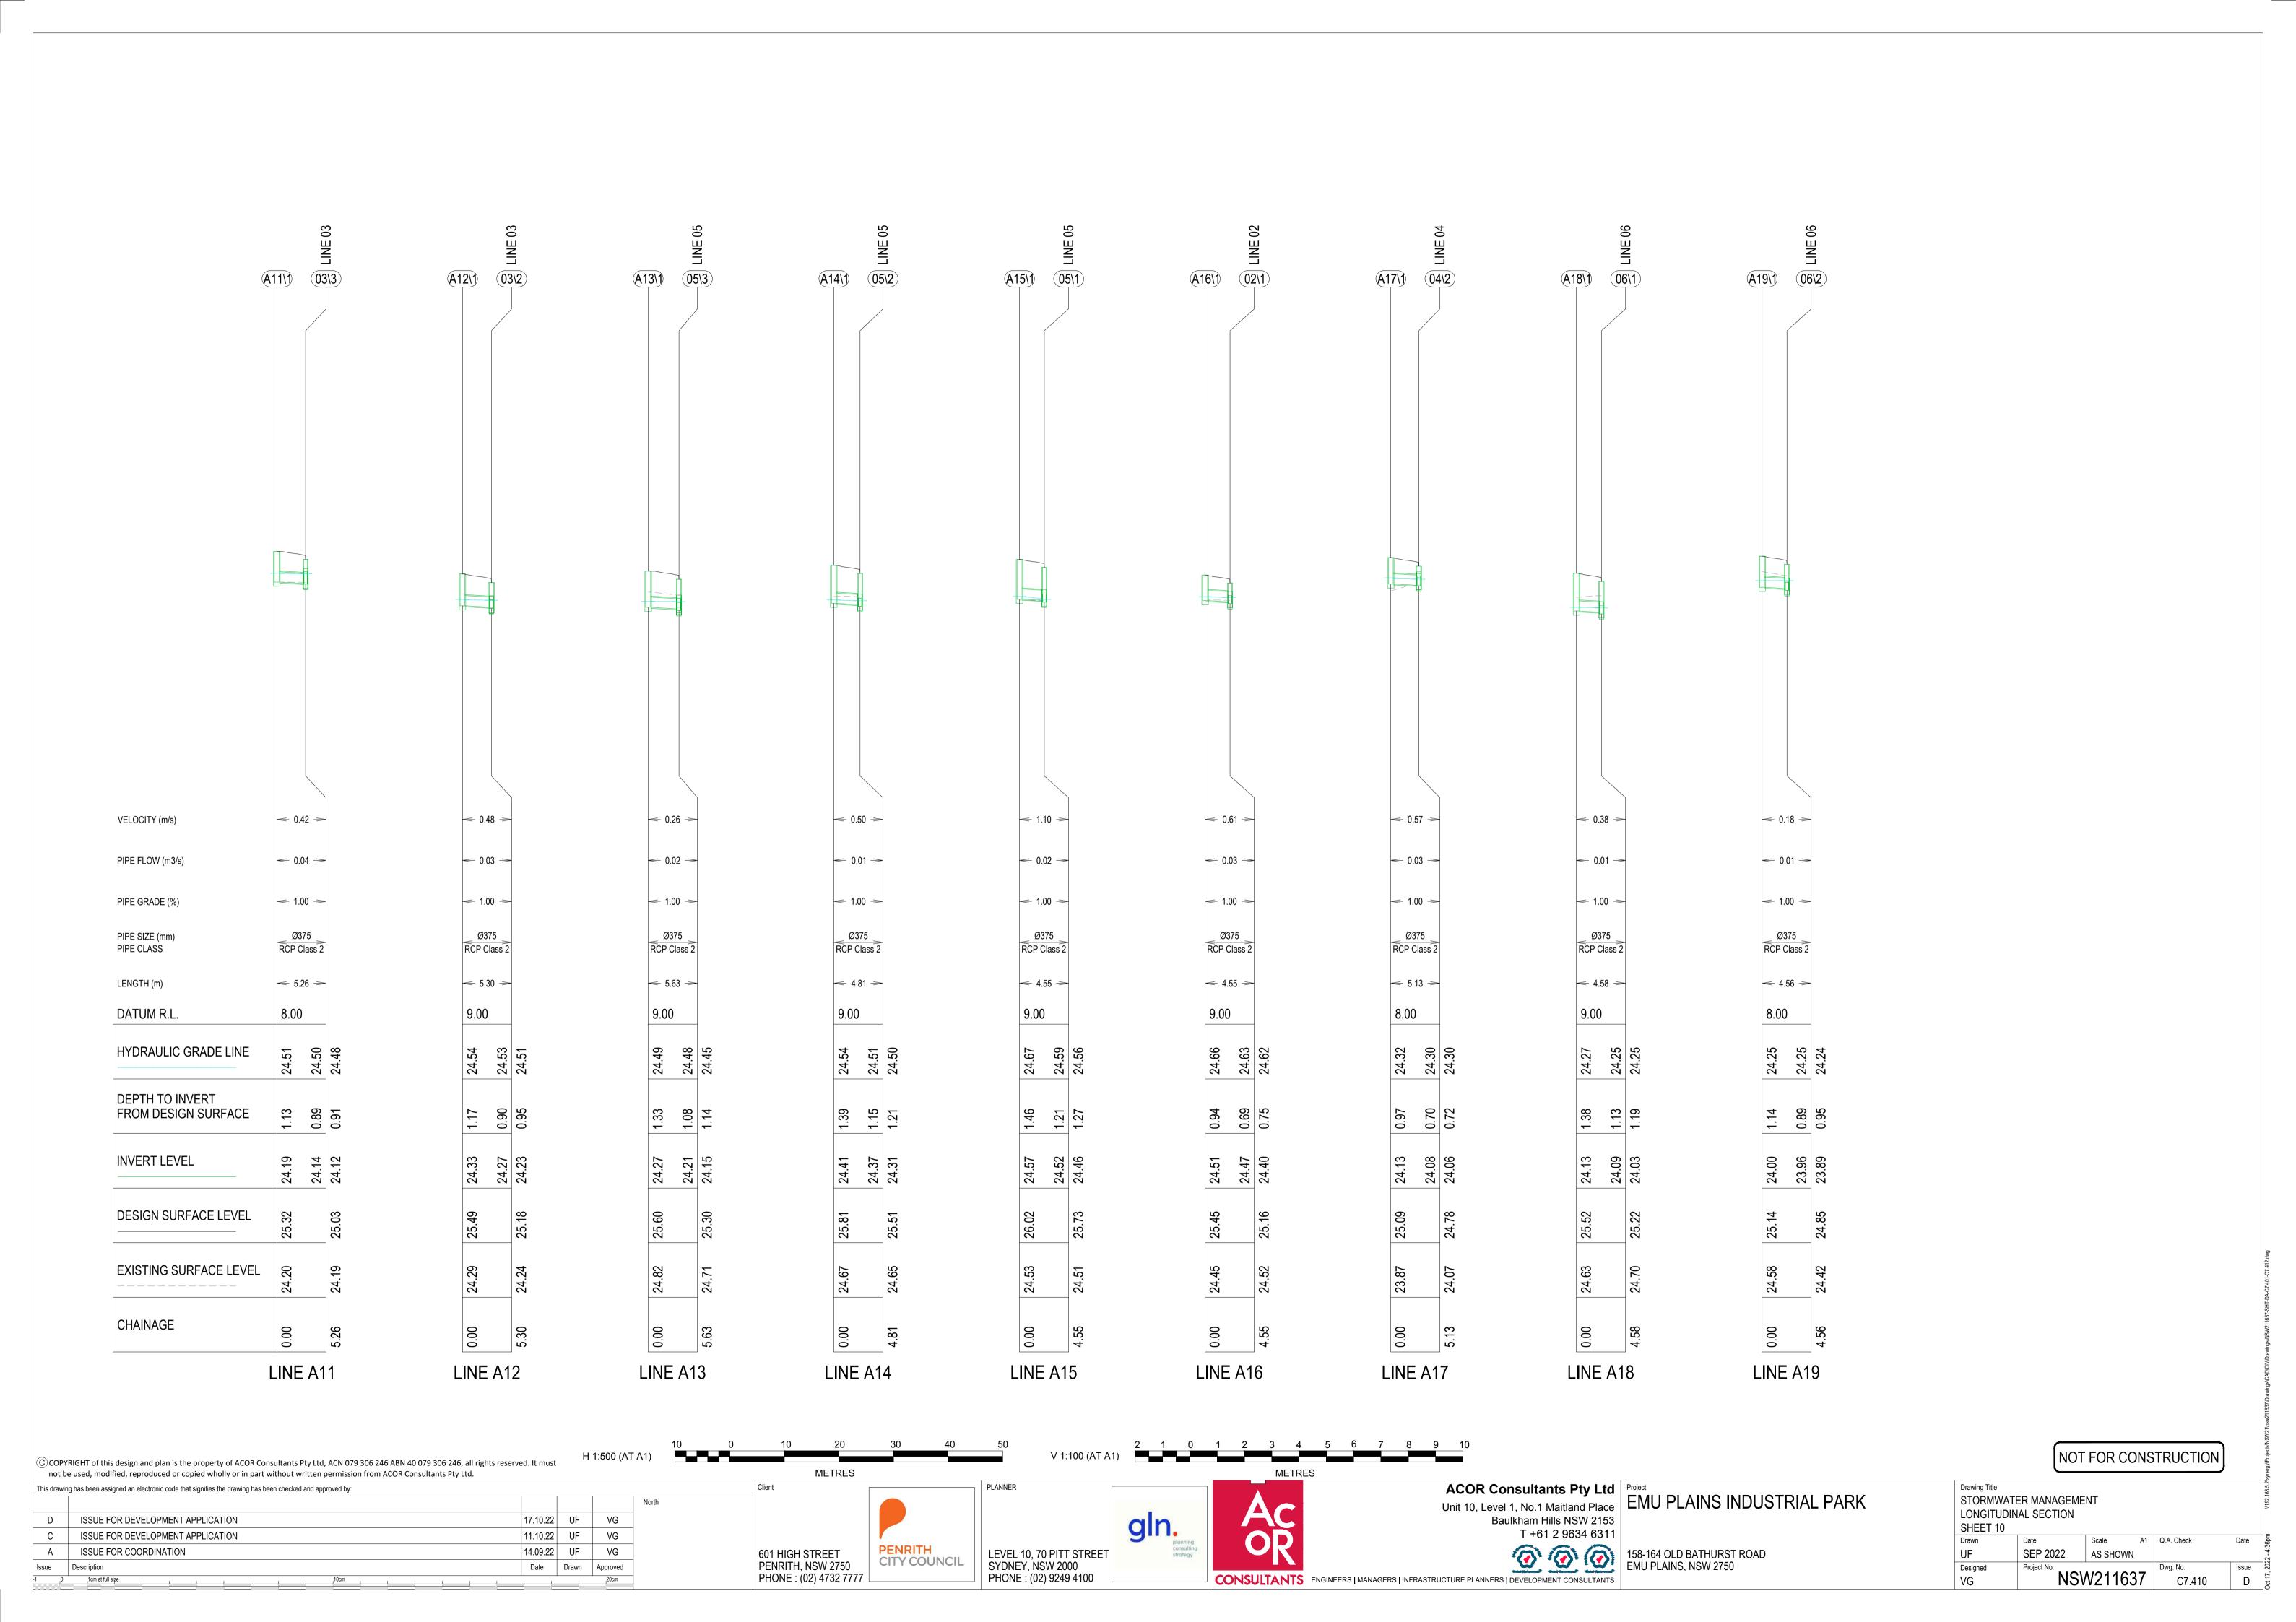

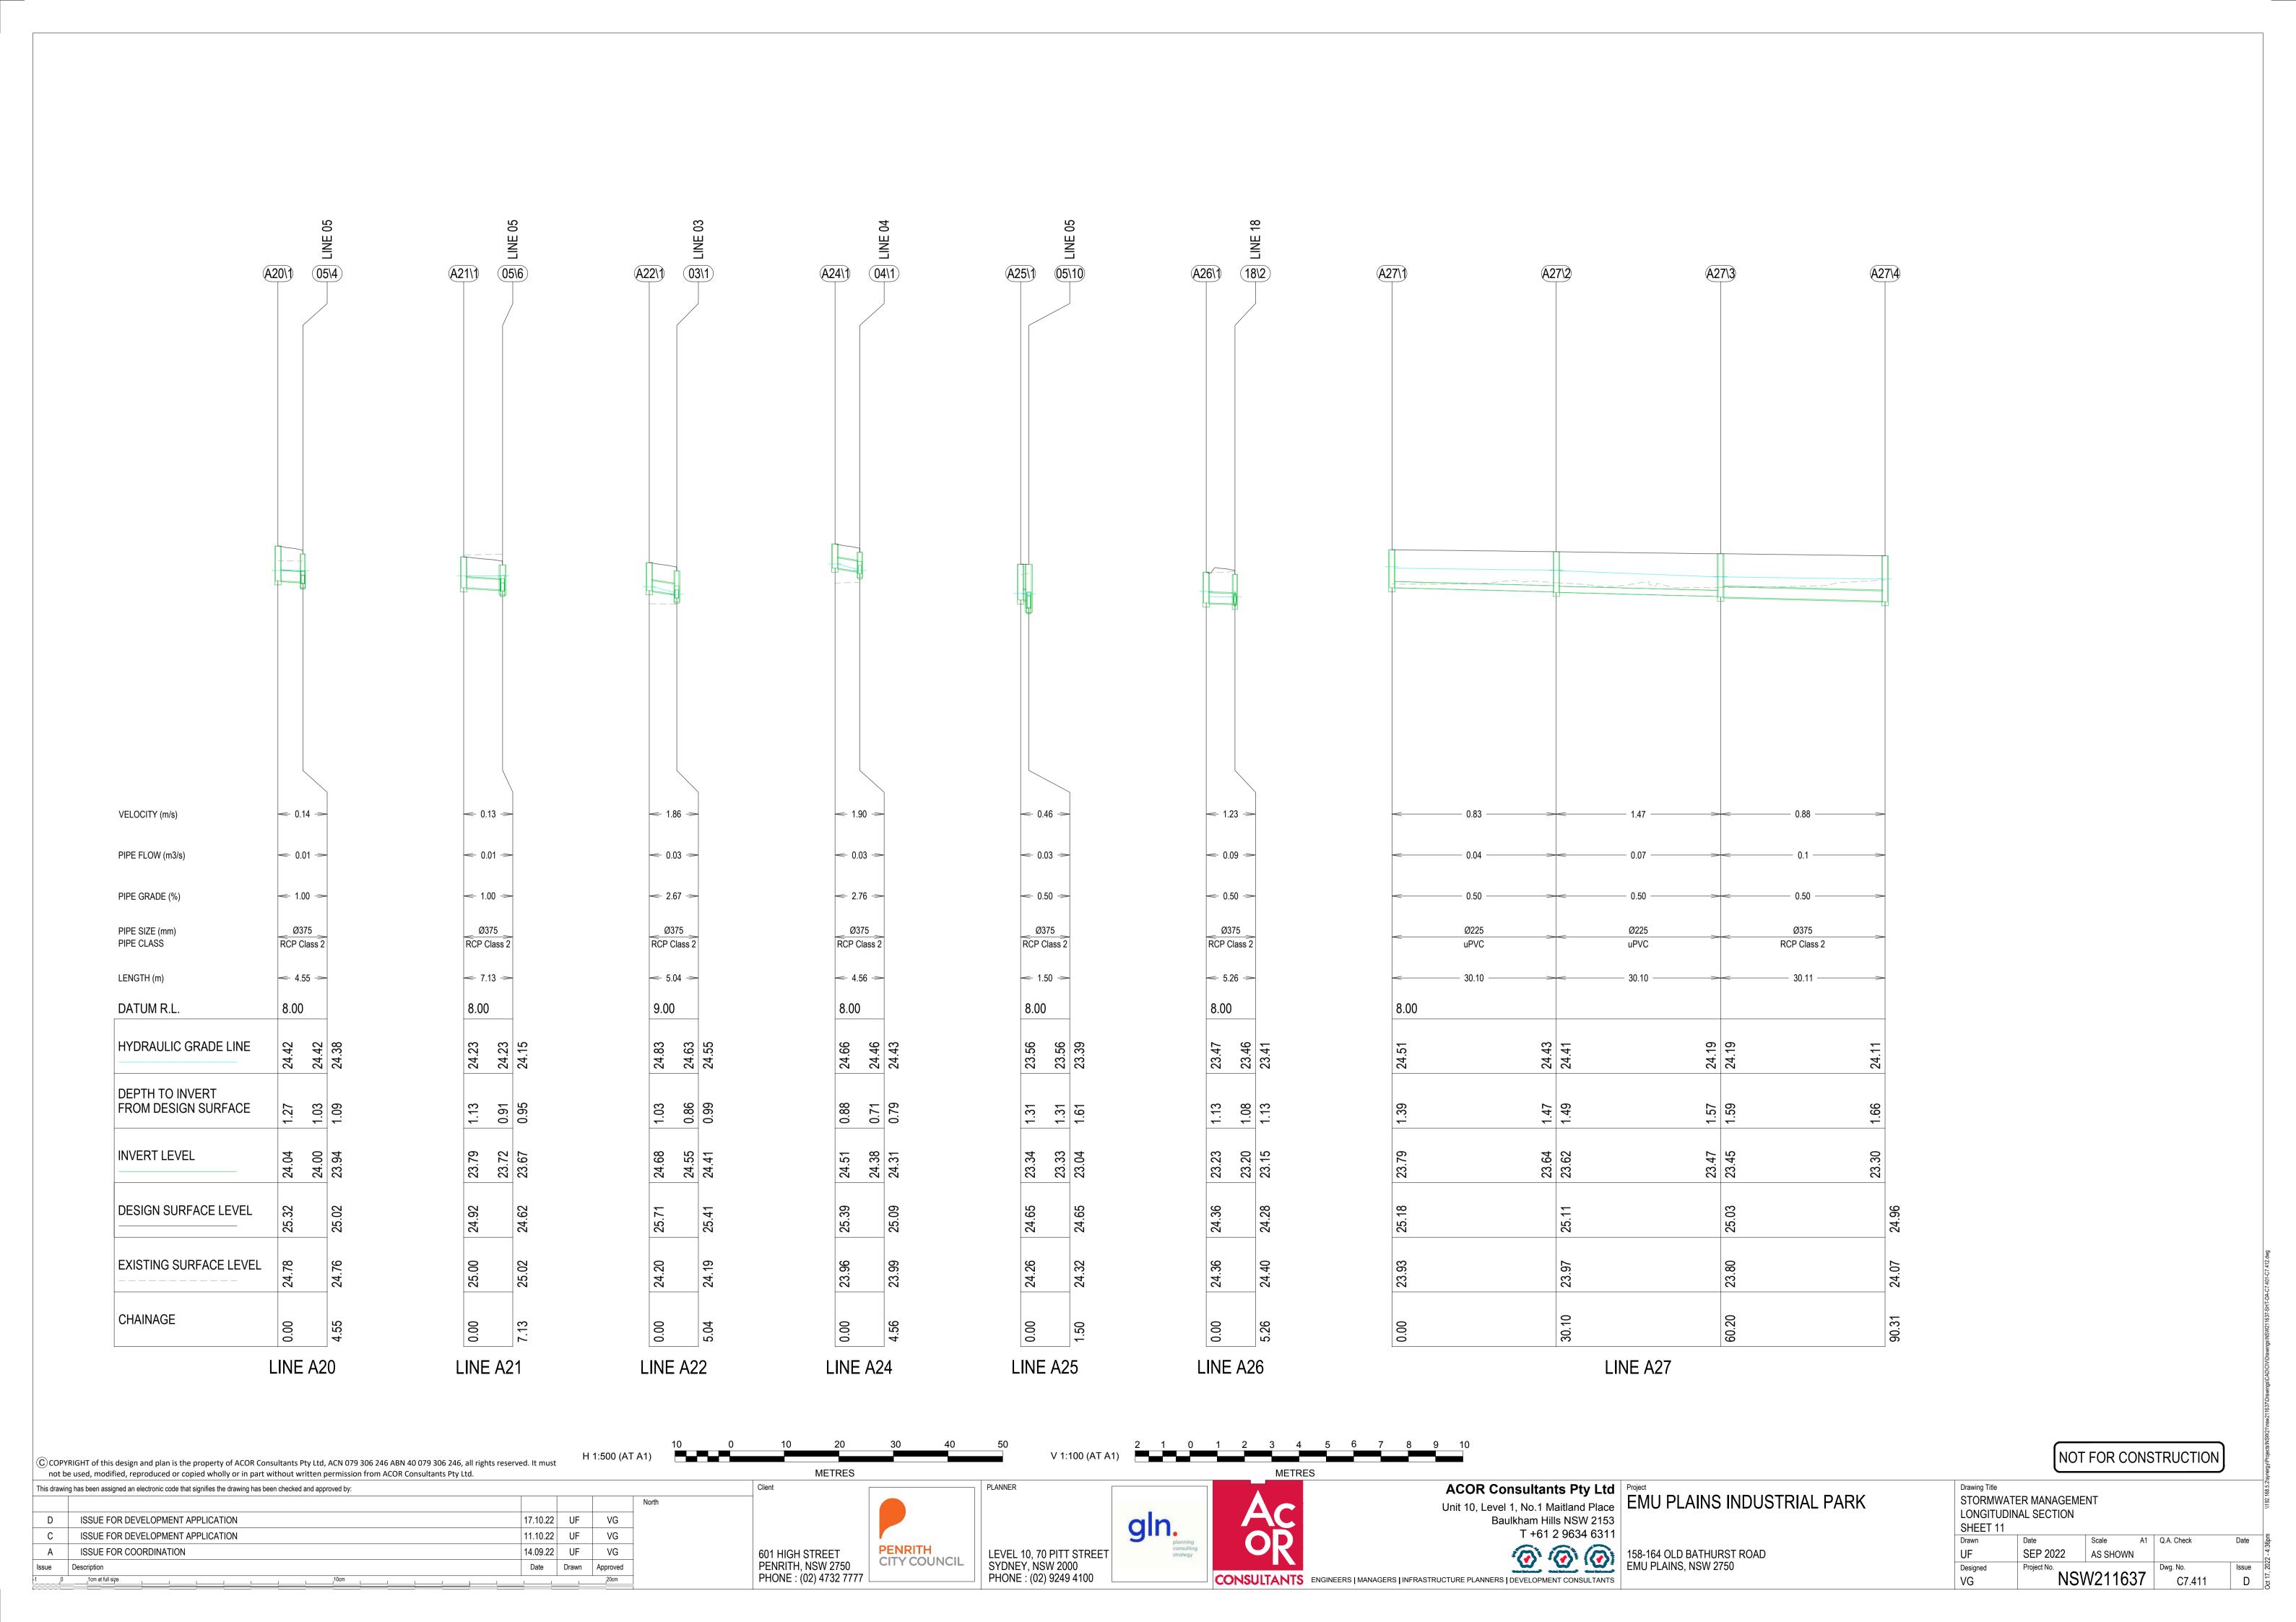

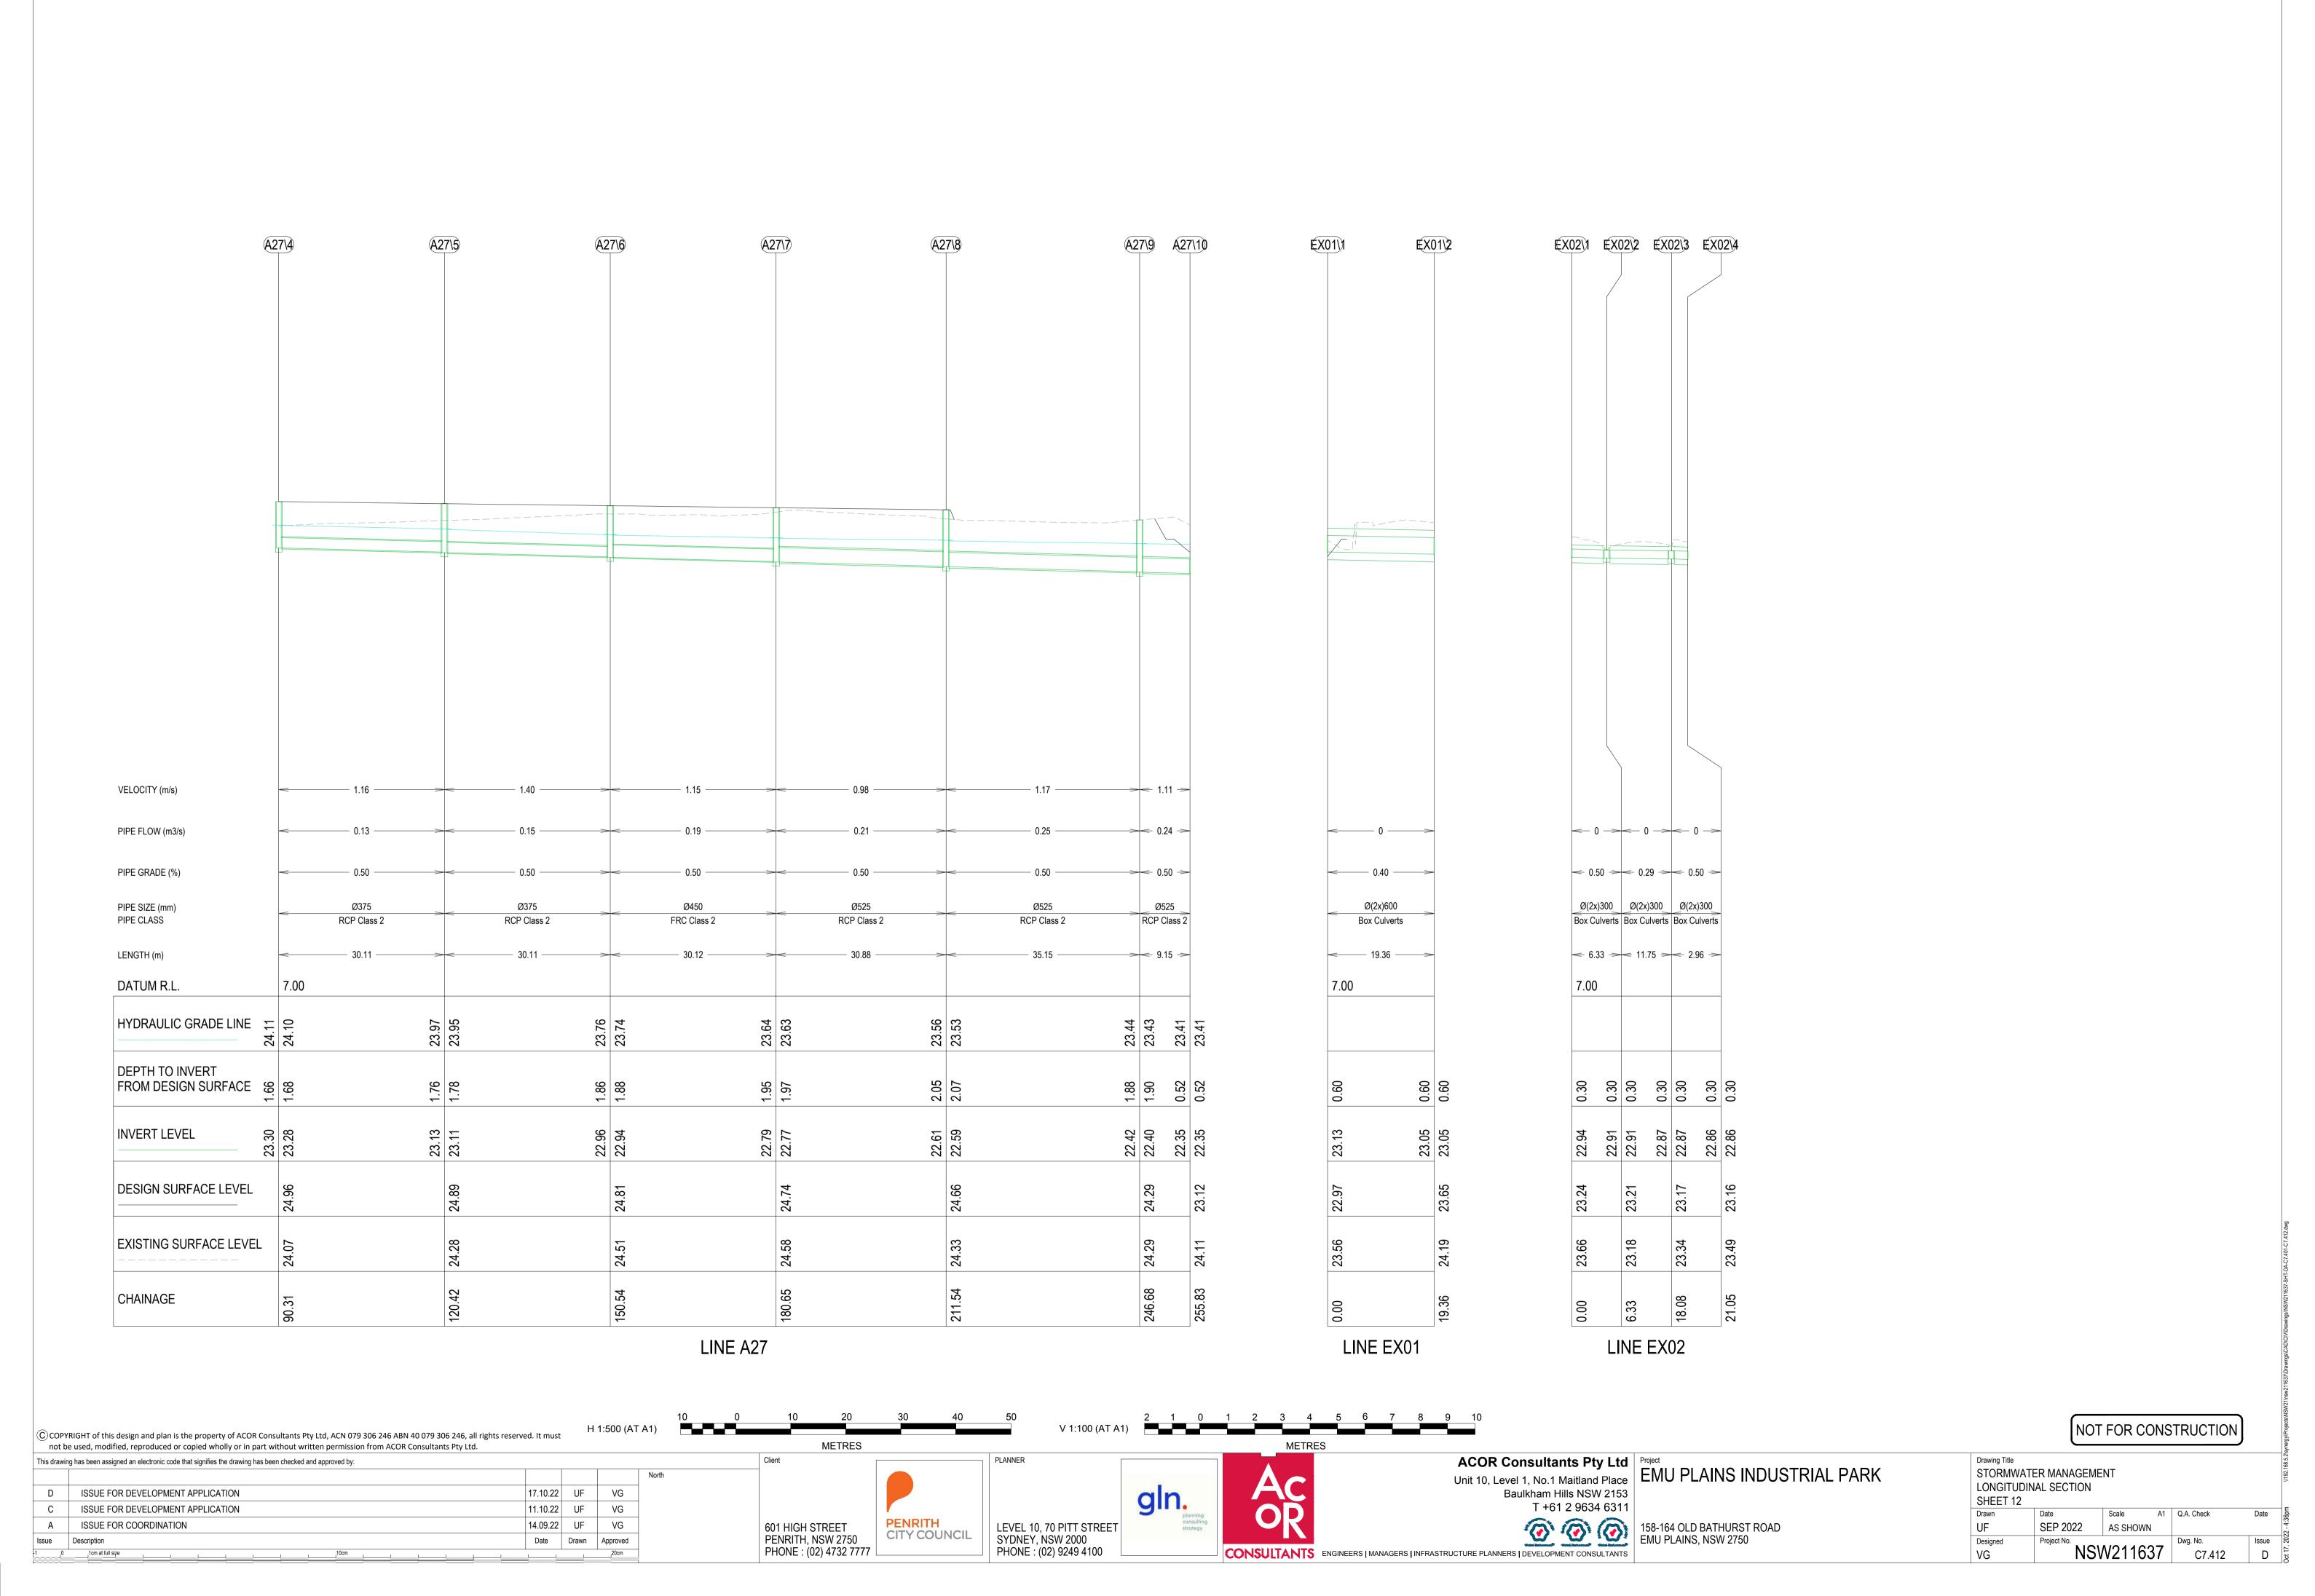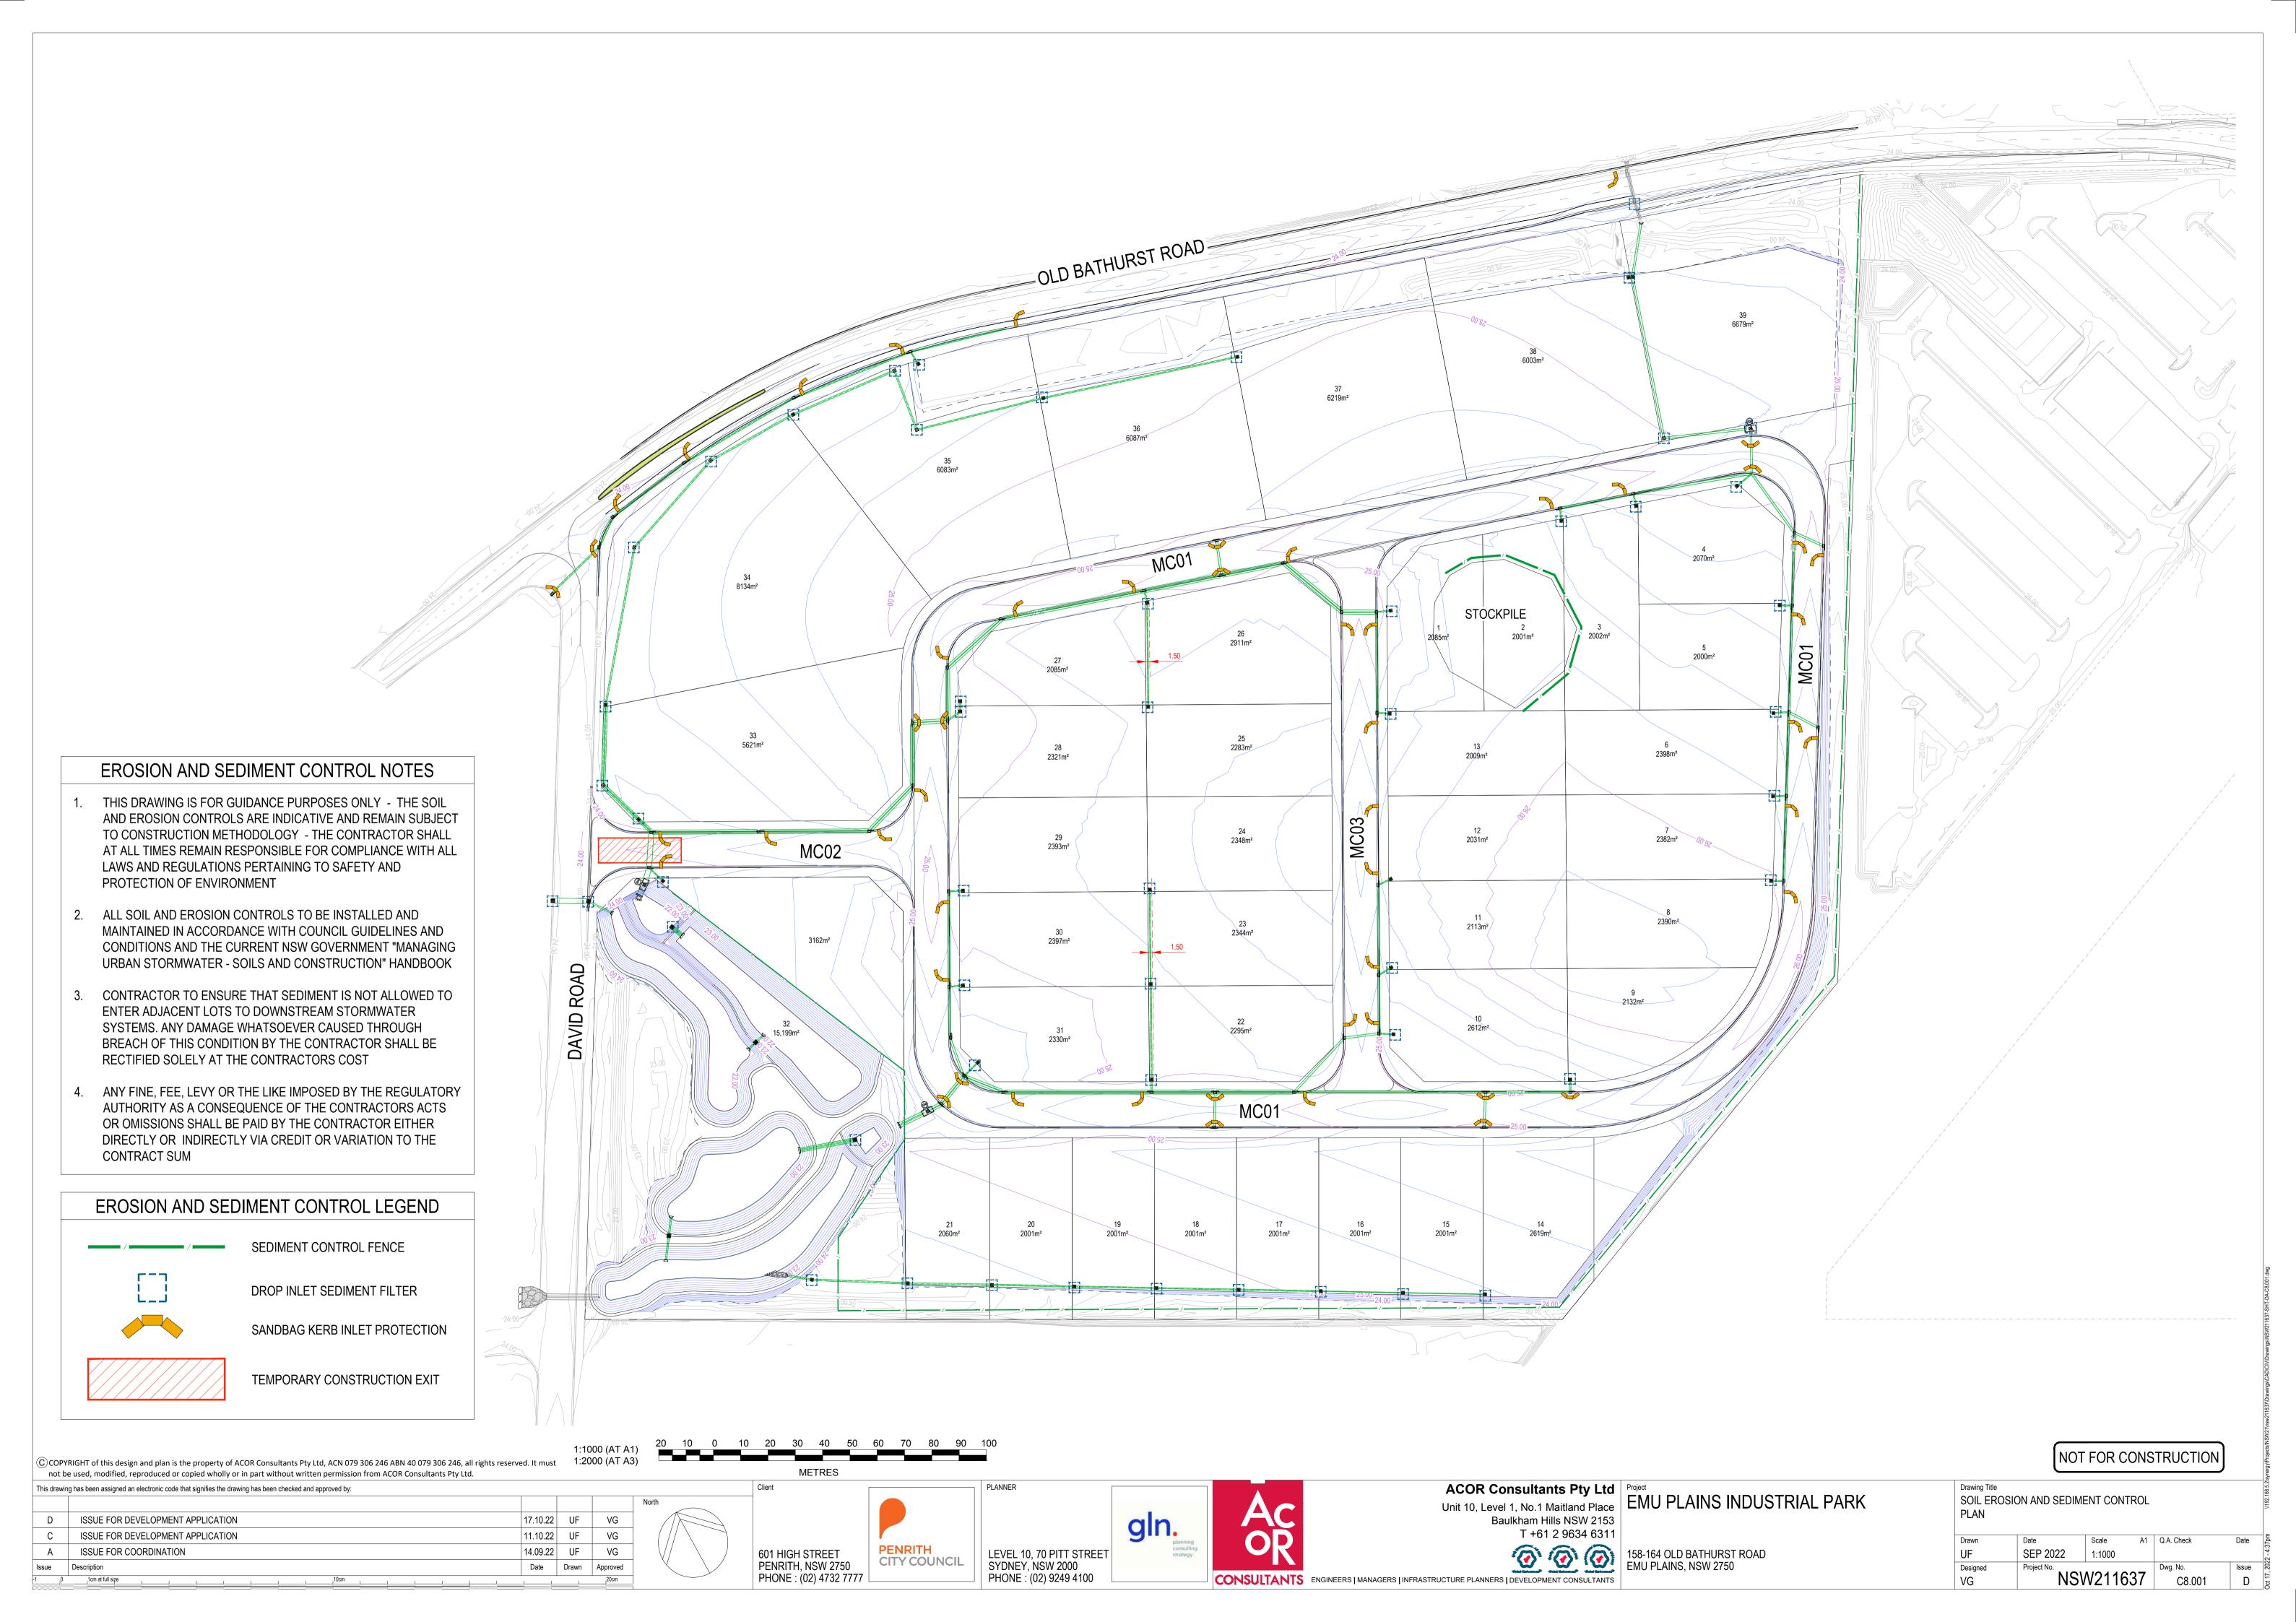



EROSION AND SEDIMENT CONTROL NOTES

GENERAL INSTRUCTIONS

- THIS SOIL AND WATER MANAGEMENT PLAN IS TO BE READ IN CONJUNCTION WITH OTHER ENGINEERING PLANS RELATING TO THIS DEVELOPMENT.
- CONTRACTORS WILL ENSURE THAT ALL SOIL AND WATER MANAGEMENT WORKS ARE UNDERTAKEN AS INSTRUCTED IN THIS SPECIFICATION AND CONSTRUCTED FOLLOWING THE GUIDELINES OF "MANAGING URBAN STORMWATER SOILS AND CONSTRUCTION", DEPT OF HOUSING, 1998 (BLUE BOOK).
- ALL SUBCONTRACTORS WILL BE INFORMED OF THEIR RESPONSIBILITIES IN REDUCING THE POTENTIAL FOR SOIL EROSION AND POLLUTION TO DOWNSLOPE AREAS.

LAND DISTURBANCE INSTRUCTIONS

- DISTURBANCE TO BE NO FURTHER THAN 5 (PREFERABLY 2) METRES FROM THE EDGE OF ANY ESSENTIAL ENGINEERING ACTIVITY AS SHOWN ON APPROVED PLANS. ALL SITE WORKERS WILL CLEARLY RECOGNISE THESE ZONES THAT, WHERE APPROPRIATE, ARE IDENTIFIED WITH BARRIER FENCING (UPSLOPE) AND SEDIMENT FENCING (DOWNSLOPE) OR SIMILAR MATERIALS.
- ACCESS AREAS ARE TO BE LIMITED TO A MAXIMUM WIDTH OF 10 METRES THE SITE MANAGER WILL DETERMINE AND MARK THE LOCATION OF THESE ZONES ON-SITE. ALL SITE WORKERS WILL CLEARLY RECOGNISE THESE BOUNDARIES THAT, WHERE APPROPRIATE, ARE IDENTIFIED WITH BARRIER FENCING (UPSLOPE) AND SEDIMENT FENCING (DOWNSLOPE) OR SIMILAR MATERIALS.
- ENTRY TO LANDS NOT REQUIRED FOR CONSTRUCTION OR ACCESS IS PROHIBITED EXCEPT FOR ESSENTIAL THINNING OF PLANT GROWTH.
- 4. WORKS ARE TO PROCEED IN THE FOLLOWING SEQUENCE:
- a. INSTALL ALL BARRIER AND SEDIMENT FENCING WHERE SHOWN ON THE PLAN.
- CONSTRUCT THE STABILISED SITE ACCESS.
- CONSTRUCT DIVERSION DRAINS AS REQUIRED.
- INSTALL MESH AND GRAVEL INLETS FOR ANY ADJACENT KERB INLETS. INSTALL GEOTEXTILE INLET FILTERS AROUND ANY ON-SITE DROP INLET PITS.
- CLEAR SITE AND STRIP AND STOCKPILE TOPSOIL IN LOCATIONS SHOWN ON THE PLAN. UNDERTAKE ALL ESSENTIAL CONSTRUCTION WORKS ENSURING THAT ROOF AND/OR
- PAVED AREA STORMWATER SYSTEMS ARE CONNECTED TO PERMANENT DRAINAGE AS
- GRADE LOT AREAS TO FINAL GRADES AND APPLY PERMANENT STABILISATION (LANDSCAPING) WITHIN 20 DAYS OF COMPLETION OF CONSTRUCTION WORKS. REMOVE TEMPORARY EROSION CONTROL MEASURES AFTER THE PERMANENT LANDSCAPING HAS BEEN COMPLETED.
- 5. ENSURE THAT SLOPE LENGTHS DO NOT EXCEED 80 METRES WHERE PRACTICABLE. SLOPE LENGTHS ARE DETERMINED BY SILTATION FENCING AND CATCH DRAIN SPACING. 6. ON COMPLETION OF MAJOR WORKS LEAVE DISTURBED LANDS WITH A SCARIFIED SURFACE TO ENCOURAGE WATER INFILTRATION AND ASSIST WITH KEYING TOPSOIL LATER.
- CONTRACTOR TO MANAGE THE ALIGNMENT OF CATCH DRAINS ON SITE AND TO ENSURE THAT CATCH DRAINS INTERCEPT THE SITE SURFACE RUNOFF AND DIRECT THE RUNOFF TOWARDS THE SEDIMENTATION BASINS.

SITE INSPECTION AND MAINTENANCE INSTRUCTIONS

- THE SITE SUPERINTENDENT WILL INSPECT THE SITE AT LEAST WEEKLY AND AT THE CONCLUSION OF EVERY STORM EVENT TO:
- a. ENSURE THAT DRAINS OPERATE PROPERLY AND TO EFFECT ANY NECESSARY
- b. REMOVE SPILLED SAND OR OTHER MATERIALS FROM HAZARD AREAS, INCLUDING LANDS CLOSER THAN 5 METRES FROM AREAS OF LIKELY CONCENTRATED OR HIGH VELOCITY FLOWS ESPECIALLY WATERWAYS AND PAVED AREAS.
- REMOVE TRAPPED SEDIMENT WHENEVER THE DESIGN CAPACITY OF THAT STRUCTURE HAS BEEN EXCEEDED.
- ENSURE REHABILITATED LANDS HAVE EFFECTIVELY REDUCED THE EROSION HAZARD AND TO INITIATE UPGRADING OR REPAIR AS NECESSARY
- CONSTRUCT ADDITIONAL EROSION AND/OR SEDIMENT CONTROL WORKS AS MIGHT BECOME NECESSARY TO ENSURE THE DESIRED PROTECTION IS GIVEN TO DOWNSLOPE LANDS AND WATERWAYS. MAKE ONGOING CHANGES TO THE PLAN WHERE IT PROVES INADEQUATE IN PRACTICE OR IS SUBJECTED TO CHANGES IN CONDITIONS ON THE WORK-SITE OR ELSEWHERE IN THE CATCHMENT.
- MAINTAIN EROSION AND SEDIMENT CONTROL STRUCTURES IN A FULLY FUNCTIONING CONDITION UNTIL ALL EARTHWORK ACTIVITIES ARE COMPLETED AND THE SITE IS REHABILITATED.
- THE SITE SUPERINTENDENT WILL KEEP A LOGBOOK MAKING ENTRIES AT LEAST WEEKLY. IMMEDIATELY BEFORE FORECAST RAIN AND AFTER RAINFALL, ENTRIES WILL INCLUDE:
- THE VOLUME AND INTENSITY OF ANY RAINFALL EVENTS.
- THE CONDITION OF ANY SOIL AND WATER MANAGEMENT WORKS. THE CONDITION OF VEGETATION AND ANY NEED TO IRRIGATE.
- THE NEED FOR DUST PREVENTION STRATEGIES.
- ANY REMEDIAL WORKS TO BE UNDERTAKEN. THE LOGBOOK WILL BE KEPT ON-SITE
- AND MADE AVAILABLE TO ANY AUTHORISED PERSON UPON REQUEST. IT WILL BE GIVEN TO THE PROJECT MANAGER AT THE CONCLUSION OF THE WORKS.

EROSION AND SEDIMENT CONTROL NOTES

SEDIMENT CONTROL INSTRUCTIONS

- SEDIMENT FENCES WILL BE INSTALLED AS SHOWN ON THE PLAN AND ELSEWHERE AT THE DISCRETION OF THE SITE SUPERINTENDENT TO CONTAIN SOIL AS NEAR AS POSSIBLE TO
- SEDIMENT FENCES WILL NOT HAVE CATCHMENT AREAS EXCEEDING 900 SQUARE METRES AND HAVE A STORAGE DEPTH OF AT LEAST 0.6 METRES.
- 3. SEDIMENT REMOVED FROM ANY TRAPPING DEVICES WILL BE RELOCATED WHERE FURTHER POLLUTION TO DOWNSLOPE LANDS AND WATERWAYS CANNOT OCCUR.
- 4. STOCKPILES ARE NOT TO BE LOCATED WITHIN 5 METRES OF HAZARD AREAS INCLUDING AREAS OF HIGH VELOCITY FLOWS SUCH AS WATERWAYS. PAVED AREAS AND DRIVEWAYS.
- WATER WILL BE PREVENTED FROM DIRECTLY ENTERING THE PERMANENT DRAINAGE SYSTEM UNLESS THE CATCHMENT AREA HAS BEEN PERMANENTLY LANDSCAPED AND/OR WATER HAS BEEN TREATED BY AN APPROVED DEVICE. 6. TEMPORARY SEDIMENT TRAPS WILL REMAIN IN PLACE UNTIL AFTER THE LANDS THEY ARE PROTECTING ARE COMPLETELY REHABILITATED.
- ACCESS TO SITES SHOULD BE STABILISED TO REDUCE THE LIKELIHOOD OF VEHICLES TRACKING SOIL MATERIALS ONTO PUBLIC ROADS AND ENSURE ALL-WEATHER ENTRY/EXIT.

SOIL EROSION CONTROL INSTRUCTIONS

- EARTH BATTERS WILL BE CONSTRUCTED WITH AS LOW A GRADIENT AS PRACTICABLE BUT NO STEEPER, UNLESS OTHERWISE NOTED, THAN:
- 2(H):1(V) WHERE SLOPE LENGTH LESS THAN 12 METRES
- 2.5(H):1(V) WHERE SLOPE LENGTH BETWEEN 12 AND 16 METRES.
- 3(H):1(V) WHERE SLOPE LENGTH BETWEEN 16 AND 20 METRES. 4(H):1(V) WHERE SLOPE LENGTH GREATER THAN 20 METRES.
- ALL WATERWAYS, DRAINS, SPILLWAYS AND THEIR OUTLETS WILL BE CONSTRUCTED TO BE STABLE IN AT LEAST THE 1:20 YEAR ARI, TIME OF CONCENTRATION STORM EVENT.
- WATERWAYS AND OTHER AREAS SUBJECT TO CONCENTRATED FLOWS AFTER CONSTRUCTION ARE TO HAVE A MAXIMUM GROUNDCOVER C-FACTOR OF 0.05 (70% GROUND COVER) WITHIN 10 WORKING DAYS FROM COMPLETION OF FORMATION. FLOW VELOCITIES ARE TO BE LIMITED TO THOSE SHOWN IN TABLE 5-1 OF "MANAGING URBAN STORMWATER -SOILS AND CONSTRUCTION", DEPT OF HOUSING 1998 (BLUE BOOK). FOOT AND VEHICULAR TRAFFIC WILL BE PROHIBITED IN THESE AREAS.
- 4. STOCKPILES AFTER CONSTRUCTION ARE TO HAVE A MAXIMUM GROUND-COVER C-FACTOR OF 0.1 (60% GROUND-COVER) WITHIN 10 WORKING DAYS FROM COMPLETION OF FORMATION.
- 5. ALL LANDS, INCLUDING WATERWAYS AND STOCKPILES, DURING CONSTRUCTION ARE TO HAVE A MAXIMUM GROUND-COVER C-FACTOR OF 0.15 (50% GROUND COVER) WITHIN 20 WORKING DAYS FROM INACTIVITY EVEN THOUGH WORKS MAY CONTINUE LATER.
- 6. FOR AREAS OF SHEET FLOW USE THE FOLLOWING GROUND COVER PLANT SPECIES FOR TEMPORARY COVER: JAPANESE MILLET 20 KG/HA AND OATS 20 KG/HA.
- PERMANENT REHABILITATION OF LANDS AFTER CONSTRUCTION WILL ACHIEVE A GROUND-COVER C-FACTOR OF LESS THAN 0.1 AND LESS THAN 0.05 WITHIN 60 DAYS. NEWLY PLANTED LANDS WILL BE WATERED REGULARLY UNTIL AN EFFECTIVE COVER IS ESTABLISHED AND PLANTS ARE GROWING VIGOROUSLY. FOLLOW-UP SEED AND FERTILISER WILL BE APPLIED AS NECESSARY.
- RE-VEGETATION SHOULD BE AIMED AT RE-ESTABLISHING NATURAL SPECIES. NATURAL SURFACE SOILS SHOULD BE REPLACED AND NON-PERSISTANT ANNUAL COVER CROPS SHOULD BE USED.

WASTE CONTROL INSTRUCTIONS

- ACCEPTABLE BINS WILL BE PROVIDED FOR ANY CONCRETE AND MORTAR SLURRIES, PAINTS, ACID WASHING, LIGHTWEIGHT WASTE MATERIALS AND LITTER. CLEARANCE SERVICES WILL BE PROVIDED AT LEAST WEEKLY. DISPOSAL OF WASTE WILL BE IN A MANNER APPROVED BT THE SITE SUPERINTENDENT.
- ALL POSSIBLE POLLUTANT MATERIALS ARE TO BE STORED WELL CLEAR OF ANY POORLY DRAINED AREAS, FLOOD PRONE AREAS, STREAMBANKS, CHANNELS AND STORMWATER DRAINAGE AREAS. STORE SUCH MATERIALS IN A DESIGNATED AREA UNDER COVER WHERE POSSIBLE AND WITHIN CONTAINMENT BUNDS.
- ALL SITE STAFF AND SUB-CONTACTORS ARE TO BE INFORMED OF THEIR OBLIGATION TO USE WASTE CONTROL FACILITIES PROVIDED.
- 4. ANY DE-WATERING ACTIVITIES ARE TO BE CLOSELY MONITORED TO ENSURE THAT WATER IS NOT POLLUTED BY SEDIMENT, TOXIC MATERIALS OR PETROLEUM PRODUCTS.
- PROVIDE DESIGNATED VEHICULAR WASHDOWN AND MAINTENANCE AREAS WHICH ARE TO HAVE CONTAINMENT BUNDS.

PREVIOUSLY LAID STRAW BALE STAKES DRIVEN 0.6M INTO THE GROUND DISTURBED AREA DIRECTION OF FLOW UNDISTURBED AREA 0.1m DEEP

ANGLE FIRST STAKE TOWARDS

DROP INLET

WITH GRATE

STRAW BALE SEDIMENT FILTER (ALTERNATE)

FILTERED

WATER

GEOTEXTILE

GEOTEXTILE FILTER FABRIC DROP

INLET SEDIMENT TRAP

DETAIL OF OVERLAP

SEDIMENT FENCE

FILTER FABRIC

GEOTEXTILE

FILTER FABRIC

RUNOFF WATER

WITH SEDIMENT

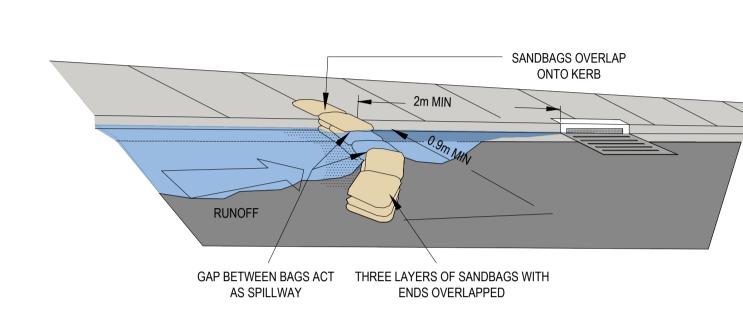
BURIED FABRIC

WIRE OR STEEL MESH

DISTURBED AREA

0.2m

0.2m



Min length 5m

50-75mm

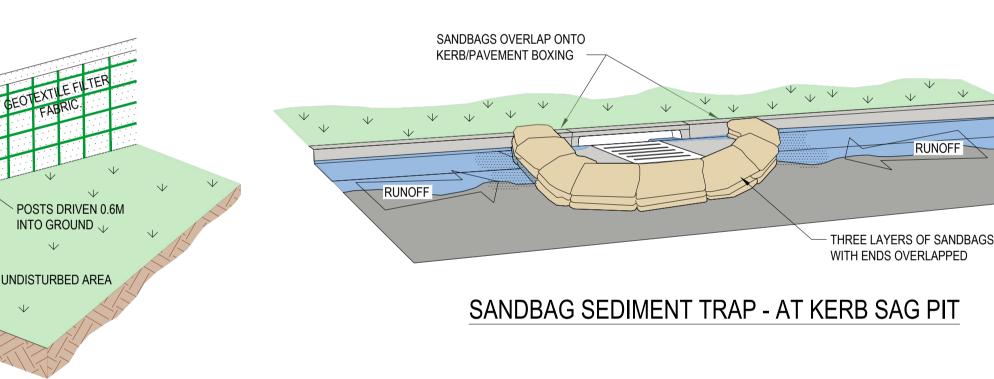
GRAVEL

TEMPORARY CONSTRUCTION EXIT

BERM (0.3M MIN. HIGH)

EXISTING ROADWAY

SANDBAG KERB INLET SEDIMENT TRAP




CONSTRUCTION SITE

GEOTEXTILE

FABRIC

RUNOFF FROM PAD DIRECTED

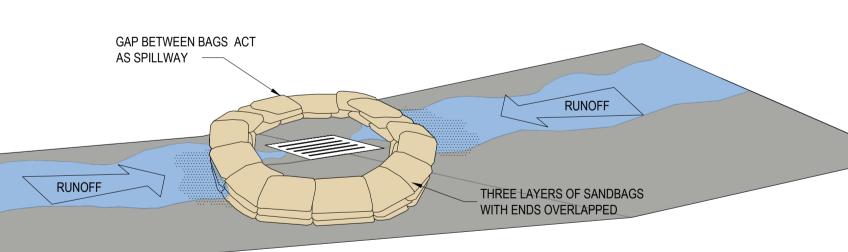TO SEDIMENT TRAP



RUNOFF

SANDBAG SEDIMENT TRAP - AT OTHER THAN KERB SAG PIT

SANDBAG SEDIMENT TRAP DETAILS

EROSION AND SEDIMENT CONTROL NOTES

IMPORTANT NOTES:

- 1. THIS DRAWINGS IS FOR GUIDANCE PURPOSES ONLY THE SOIL AND EROSION CONTROLS ARE INDICATIVE AND REMAIN SUBJECT TO CONSTRUCTION METHODOLOGY - THE CONTRACTOR SHALL AT ALL TIMES REMAIN RESPONSIBLE FOR COMPLIANCE WITH ALL LAWS AND REGULATIONS PERTAINING TO SAFETY AND PROTECTION OF ENVIRONMENT
- ALL SOIL AND EROSION CONTROLS TO BE INSTALLED AND MAINTAINED IN ACCORDANCE WITH COUNCIL GUIDELINES AND CONDITIONS AND THE CURRENT NSW DEPT OF CONSERVATION AND LAND MANAGEMENT "URBAN EROSION AND SEDIMENT CONTROL" HANDBOOK
- 3. CONTRACTOR TO ENSURE THAT SEDIMENT IS NOT ALLOWED TO ENTER ADJACENT LOTS TO DOWNSTREAM STORMWATER SYSTEMS OR ANY PUBLIC ROAD OR ROAD RELATED AREA. ANY DAMAGE WHATSOEVER CAUSED THROUGH BREACH OF THIS CONDITION BY THE CONTRACTOR SHALL BE RECTIFIED SOLELY AT THE CONTRACTORS COST
- 4. THE CONTRACTOR IS TO REMOVE ANY SEDIMENT DEPOSITS OUTSIDE THE SITE BY THE END OF EACH WORKING DAY BY VACUUM SWEEPER TRUCKS.
- WHOLE OF SITE TO BE REVEGETATED WITH HYDROMULCH WITHIN FIVE DAYS OF REACHING FSL AND COMPLETION OF TRENCH WORKS TO "MANAGING" URBAN STORMWATER - SOILS AND CONSTRUCTION VOL. 1" REQUIREMENTS.

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ISSUE FOR DEVELOPMENT APPLICATION 17.10.22 UF VG ISSUE FOR DEVELOPMENT APPLICATION 11.10.22 UF VG ISSUE FOR COORDINATION 14.09.22 UF VG Issue Description Approved

PENRITH 601 HIGH STREET CITY COUNCIL PENRITH, NSW 2750 PHONE: (02) 4732 7777









ACOR Consultants Pty Ltd Baulkham Hills NSW 2153

T +61 2 9634 6311

Unit 10, Level 1, No.1 Maitland Place | EMU PLAINS INDUSTRIAL PARK

158-164 OLD BATHURST ROAD

EMU PLAINS. NSW 2750

SOIL EROSION AND SEDIMENT CONTROL NOTES AND DETAILS

MAINTENANCE

BE REMOVED IMMEDIATELY.

THE ENTRANCE SHALL BE MAINTAINED IN A CONDITION WHICH

PREVENTS TRACKING OR FLOWING OF SEDIMENT ONTO

DRESSING WITH ADDITIONAL GRAVEL AS CONDITIONS

PUBLIC RIGHTS OF WAY. THIS MAY REQUIRE PERIODIC TOP

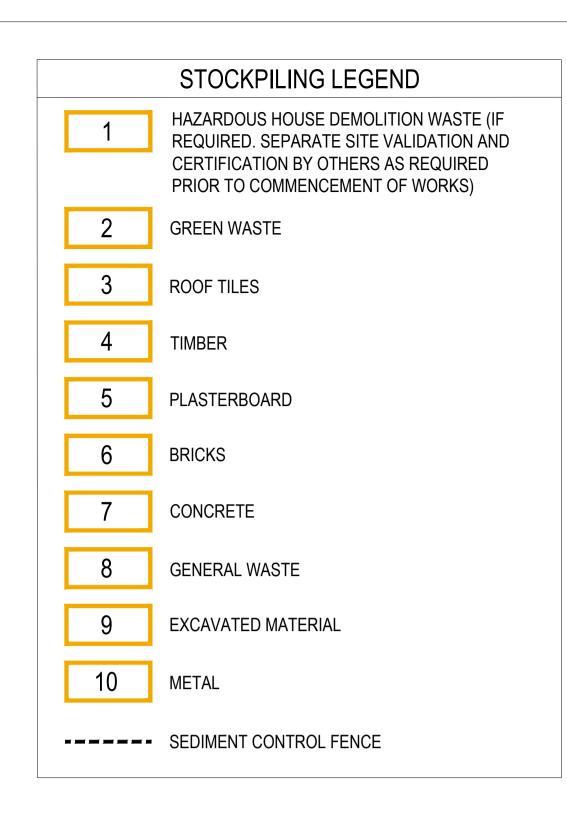
DEMAND AND REPAIR AND / OR CLEANOUT OF ANY MEASURES

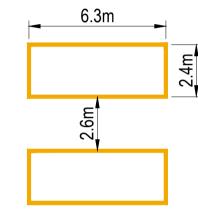
USED TO TRAP SEDIMENT. ALL SEDIMENT SPILLED, DROPPED.

WASHED OR TRACKED ONTO PUBLIC RIGHTS OF WAY MUST

A1 Q.A. Check Scale UF SEP 2022 NOT TO SCALE NSW211637 VG C8.101

NOT FOR CONSTRUCTION





TYPICAL 30 HOOK SKIP BIN (BINGO INDUSTRIES) NOT TO SCALE



1:1000 (AT A1) 1:2000 (AT A3) © COPYRIGHT of this design and plan is the property of ACOR Consultants Pty Ltd, ACN 079 306 246 ABN 40 079 306 246, all rights reserved. It must **METRES**

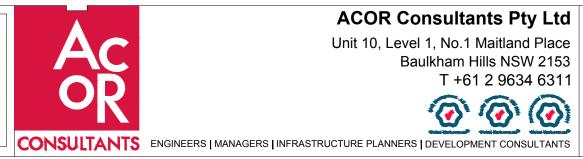
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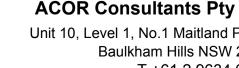
ISSUE FOR DEVELOPMENT APPLICATION 17.10.22 UF VG ISSUE FOR DEVELOPMENT APPLICATION 11.10.22 UF VG 14.09.22 UF ISSUE FOR COORDINATION VG Date Drawn Approved

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Baulkham Hills NSW 2153

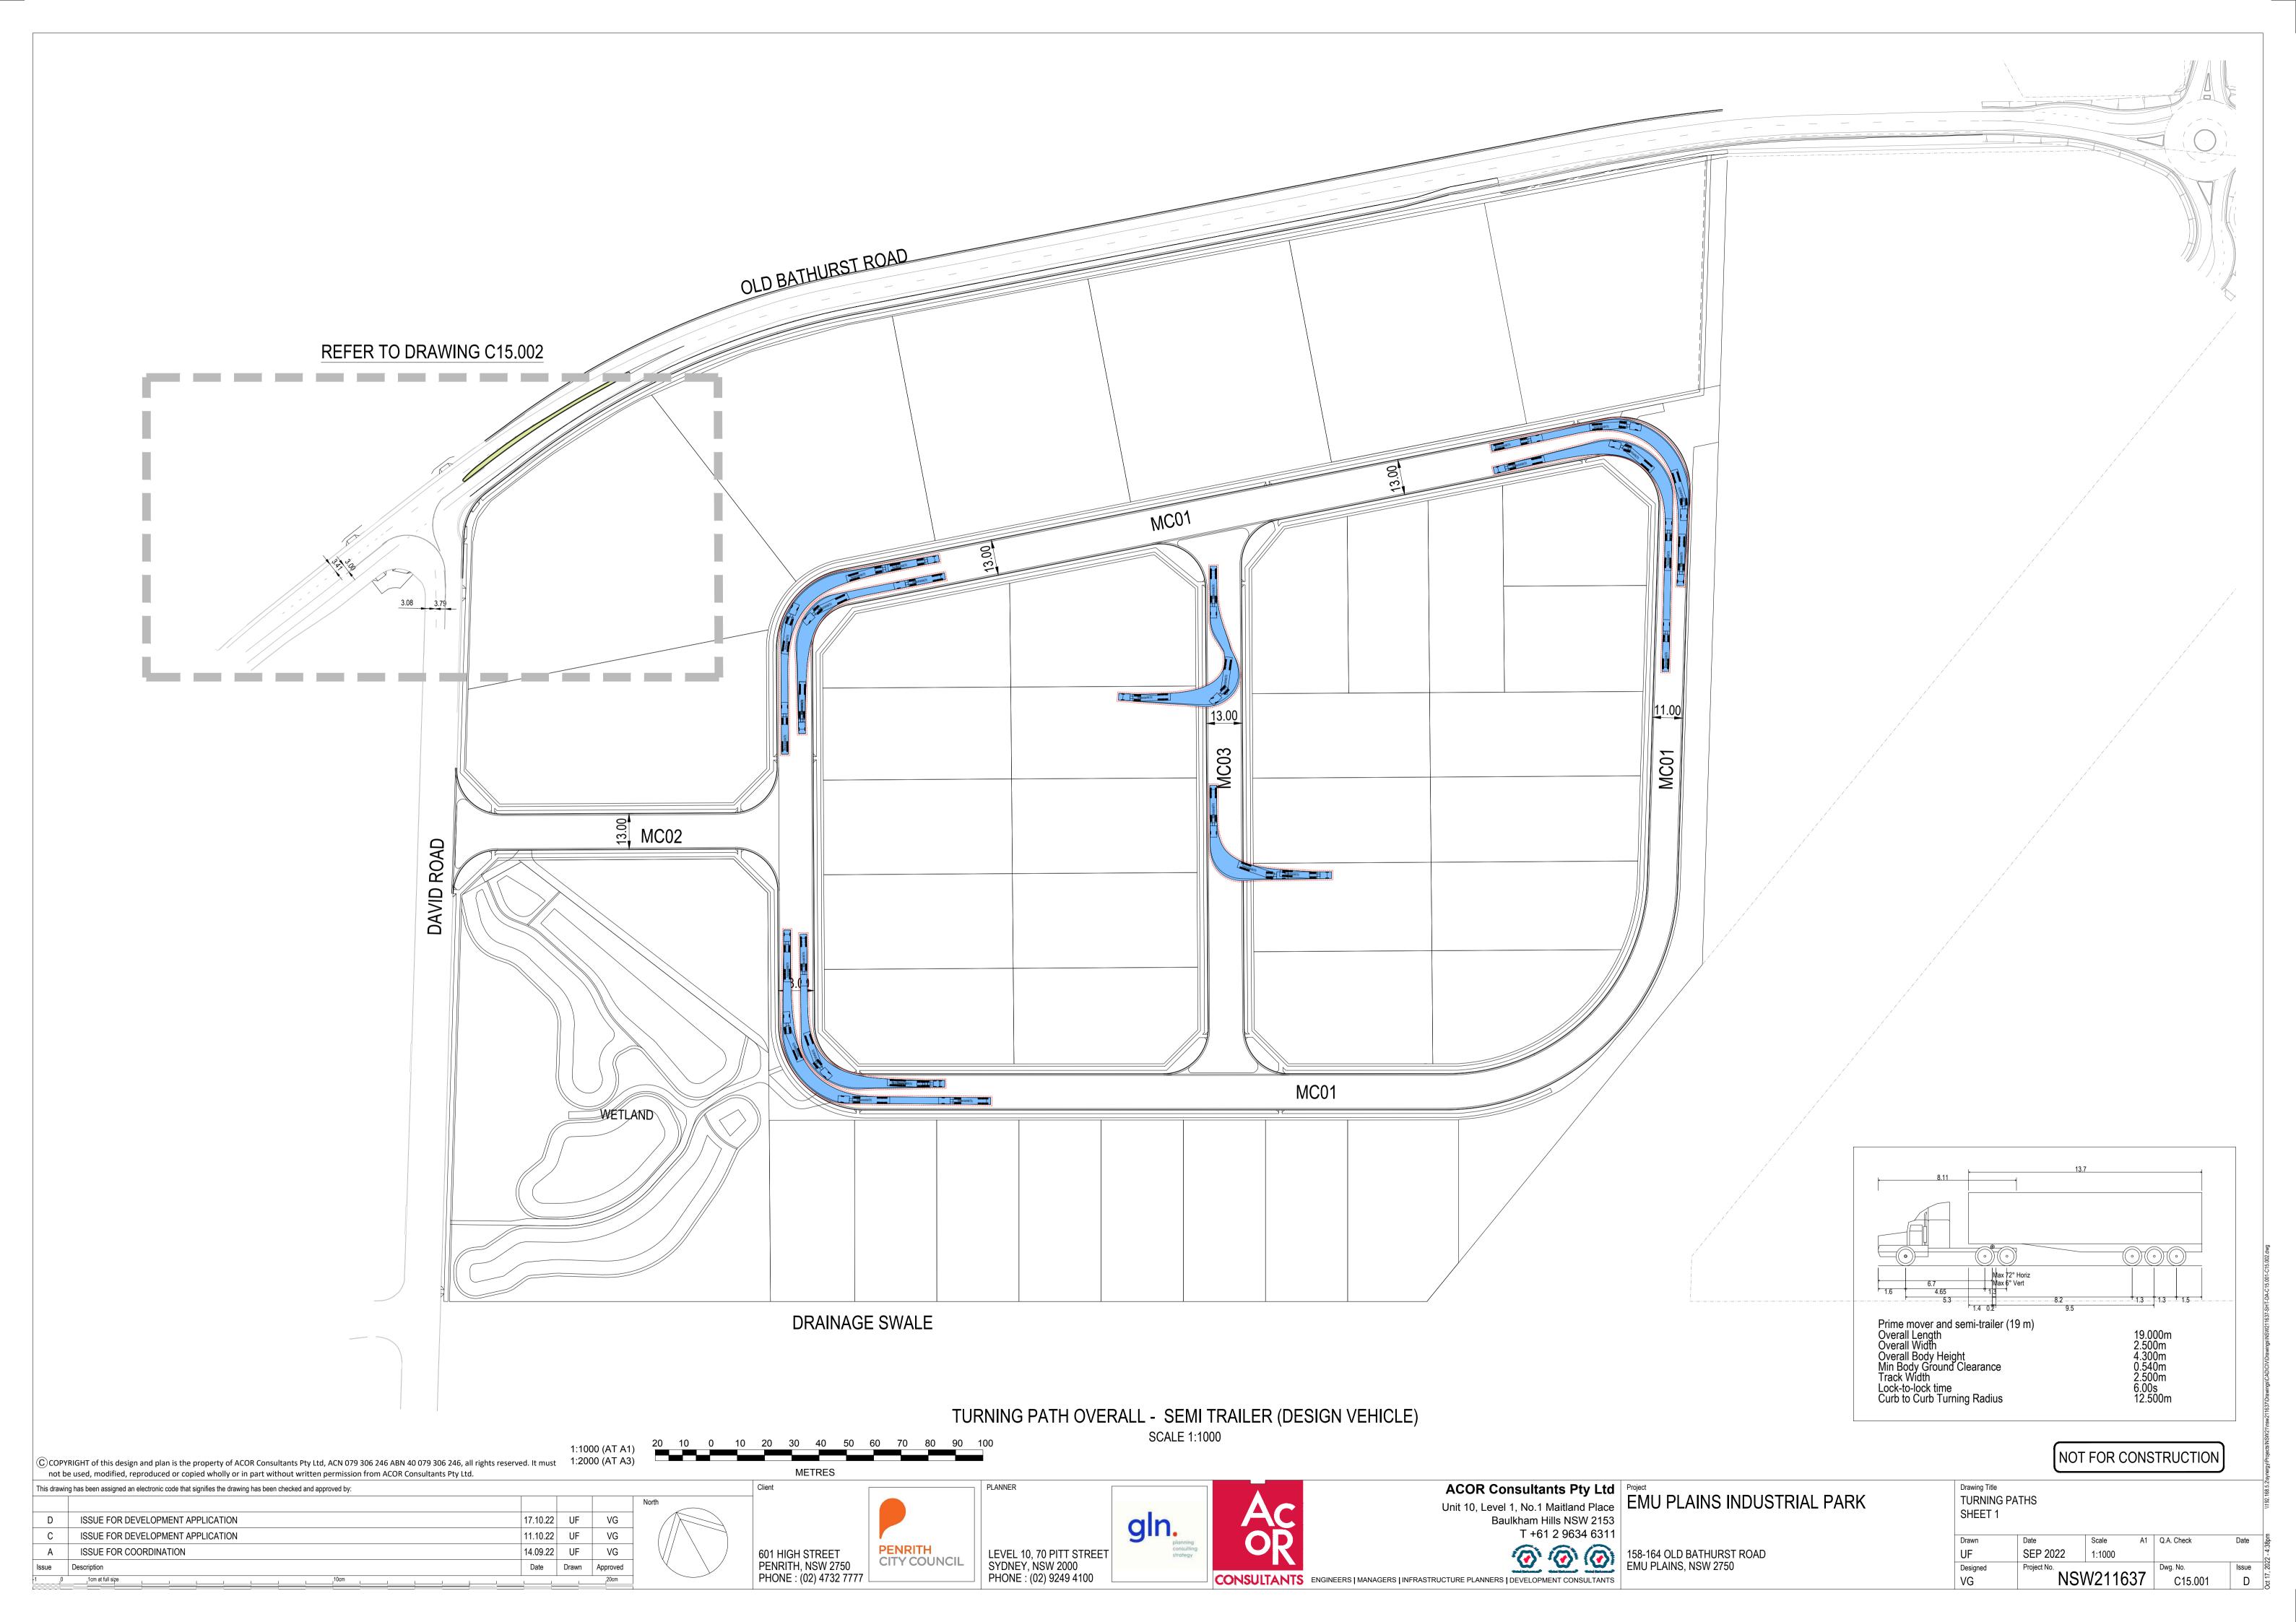
Project

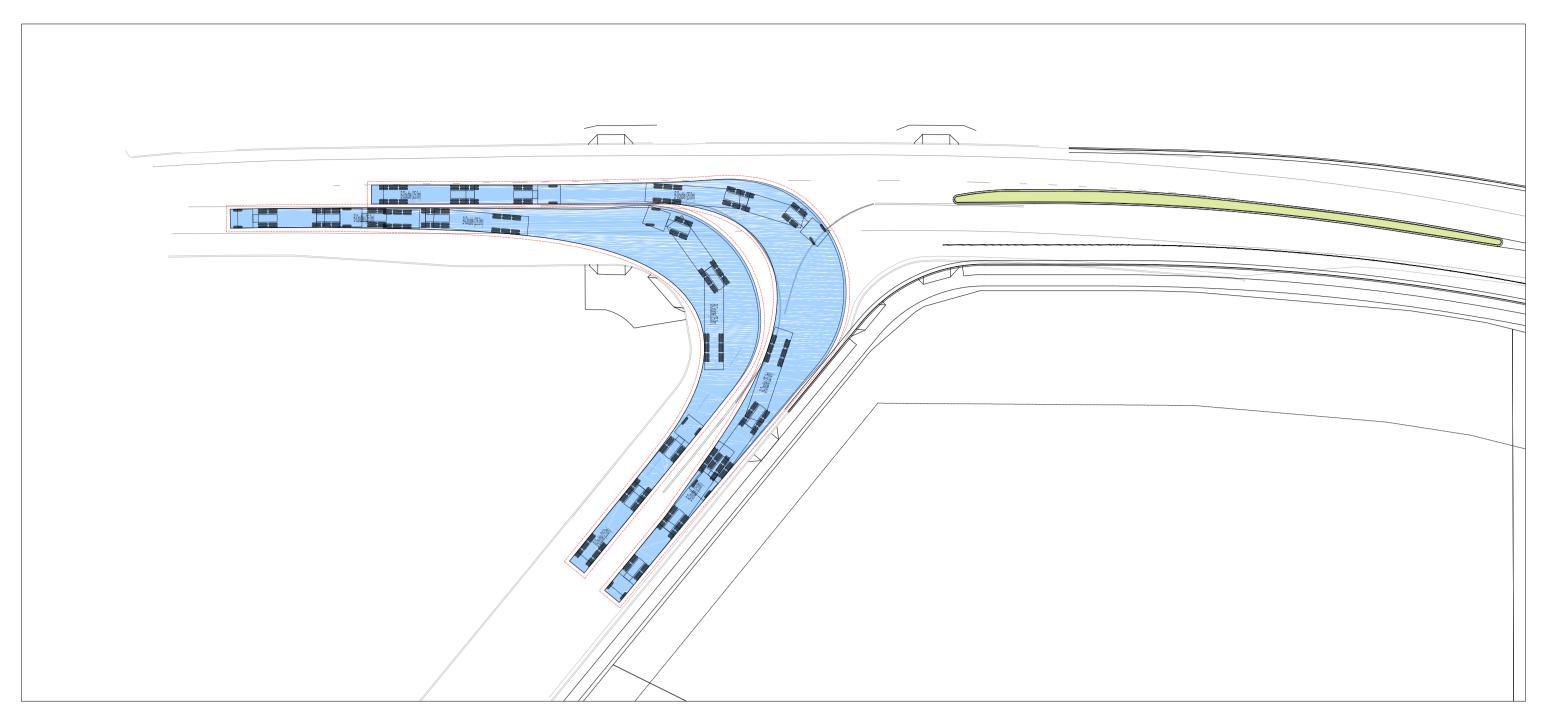
EMU PLAINS INDUSTRIAL PARK

158-164 OLD BATHURST ROAD EMU PLAINS, NSW 2750


NOT FOR CONSTRUCTION WASTE MANAGEMENT

PLAN A1 Q.A. Check SEP 2022 1:1000 UF NSW211637 C11.001






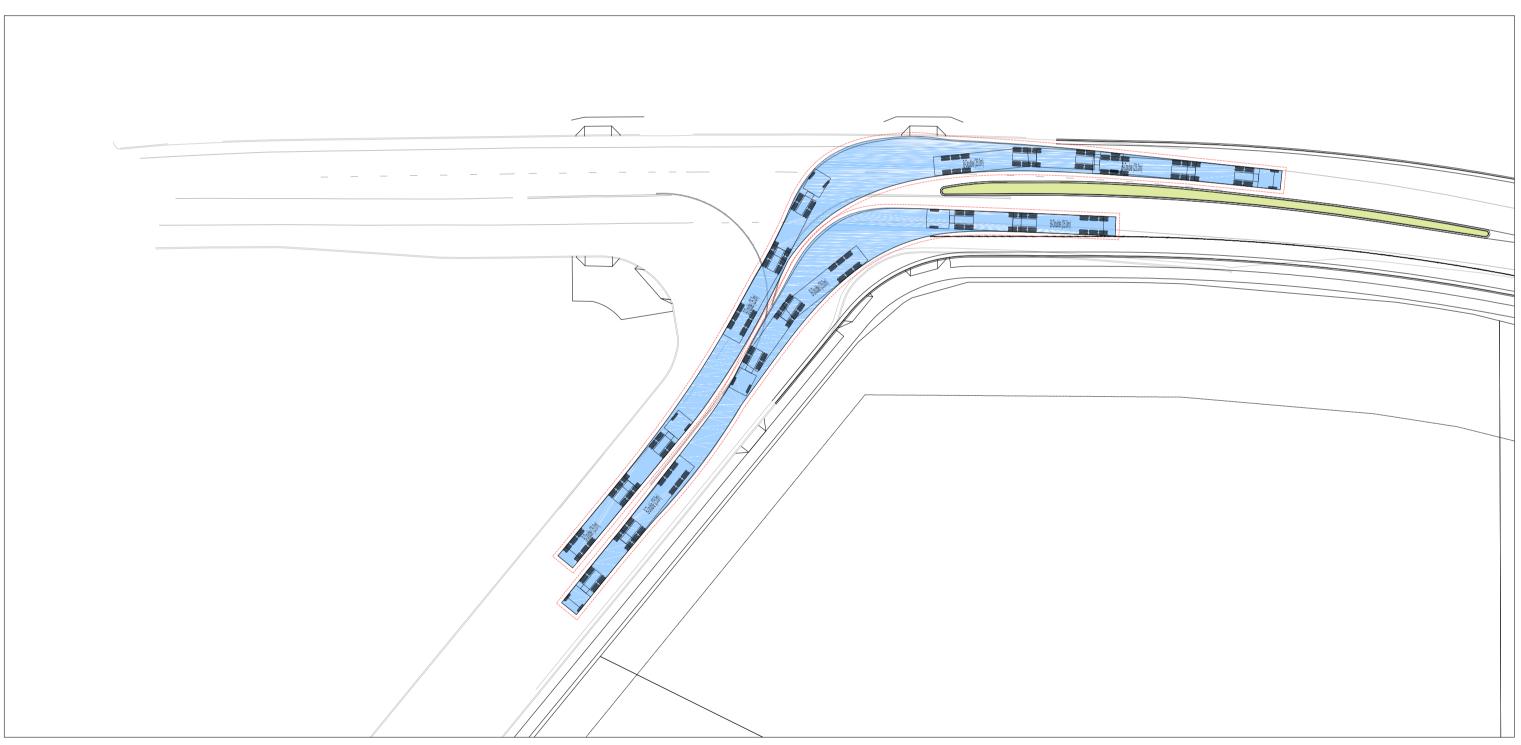INTERSECTION OLD BATHURST ROAD WITH DAVID ROAD (SOUTH BOUND) SCALE 1:500



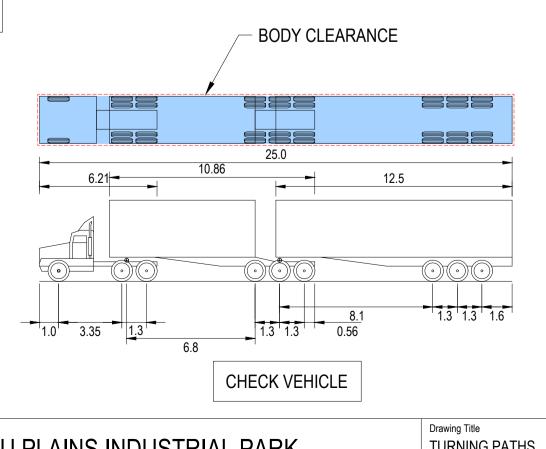INTERSECTION OLD BATHURST ROAD WITH DAVID ROAD (EAST/WEST BOUND) SCALE 1:500



25m ARTICULATED VEHICLE (B-DOUBLE)

25.000m
2.500m
4.300m
0.540m
2.500m
6.00s
15.000m
15km/h

NOT FOR CONSTRUCTION


1:500 (AT A1) 1:1000 (AT A3) **METRES**

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ACOR Consultants Pty Ltd
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Baulkham Hills NSW 2153

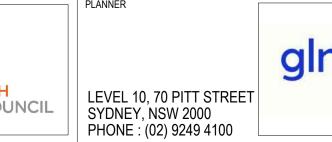Project
EMU PLAINS INDUSTRIAL PARK

SHEET 2						
Drawn	Date	Scale	A1	Q.A. Check		
UF	SEP 2022	1:500				
Designed	Project No.			Dwg. No.		
VG	NSV	NSW211637				